


Sheet Number	Sheet Name	Revision
MPT_F000	Sheet List	1
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MPT_F101	Window - Aluminium Head Detail	1
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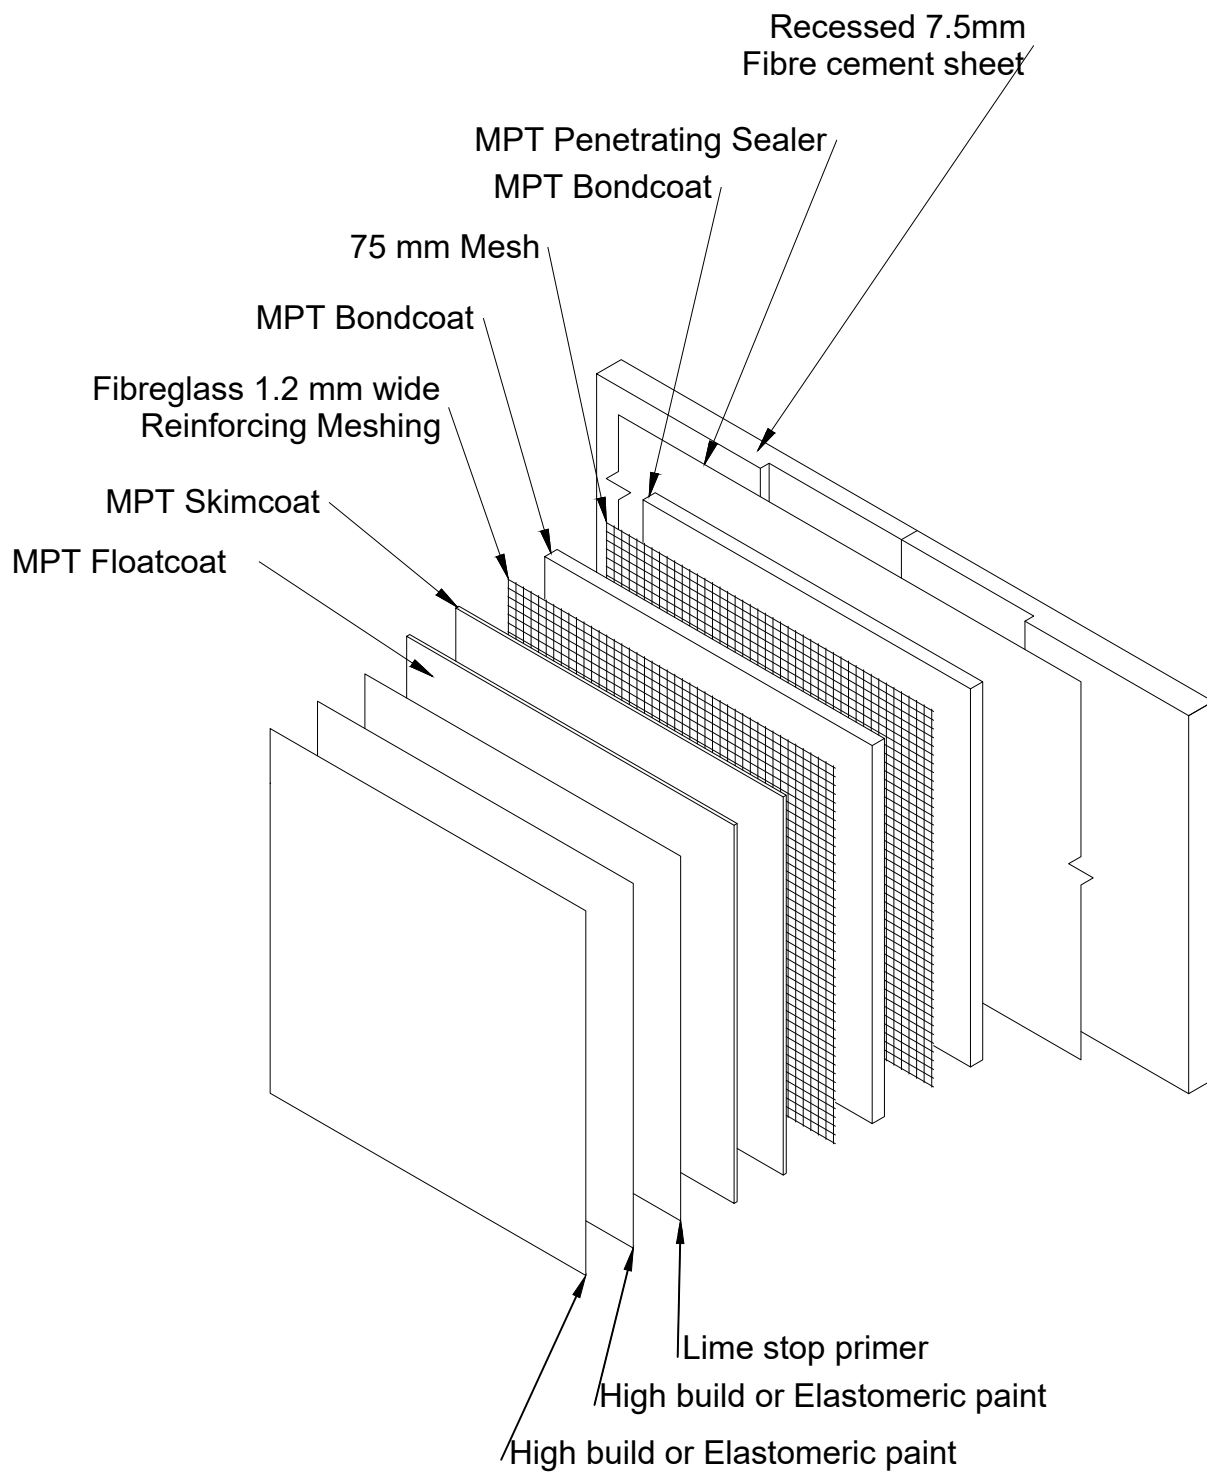
Grand total: 30

Note: Sheet numbers are not sequential

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 Mineral Plaster Technology 61 Hillside Rd, Wairau Valley Auckland 0627 New Zealand www.mineralplaster.co.nz Ph: 0800 25 23 678	MPT Fibreclad System Sheet List	Reference: MPT_F000
		Date: June 2019
		Scale: NTS
		Revision: 2

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MPT Fibreclad System

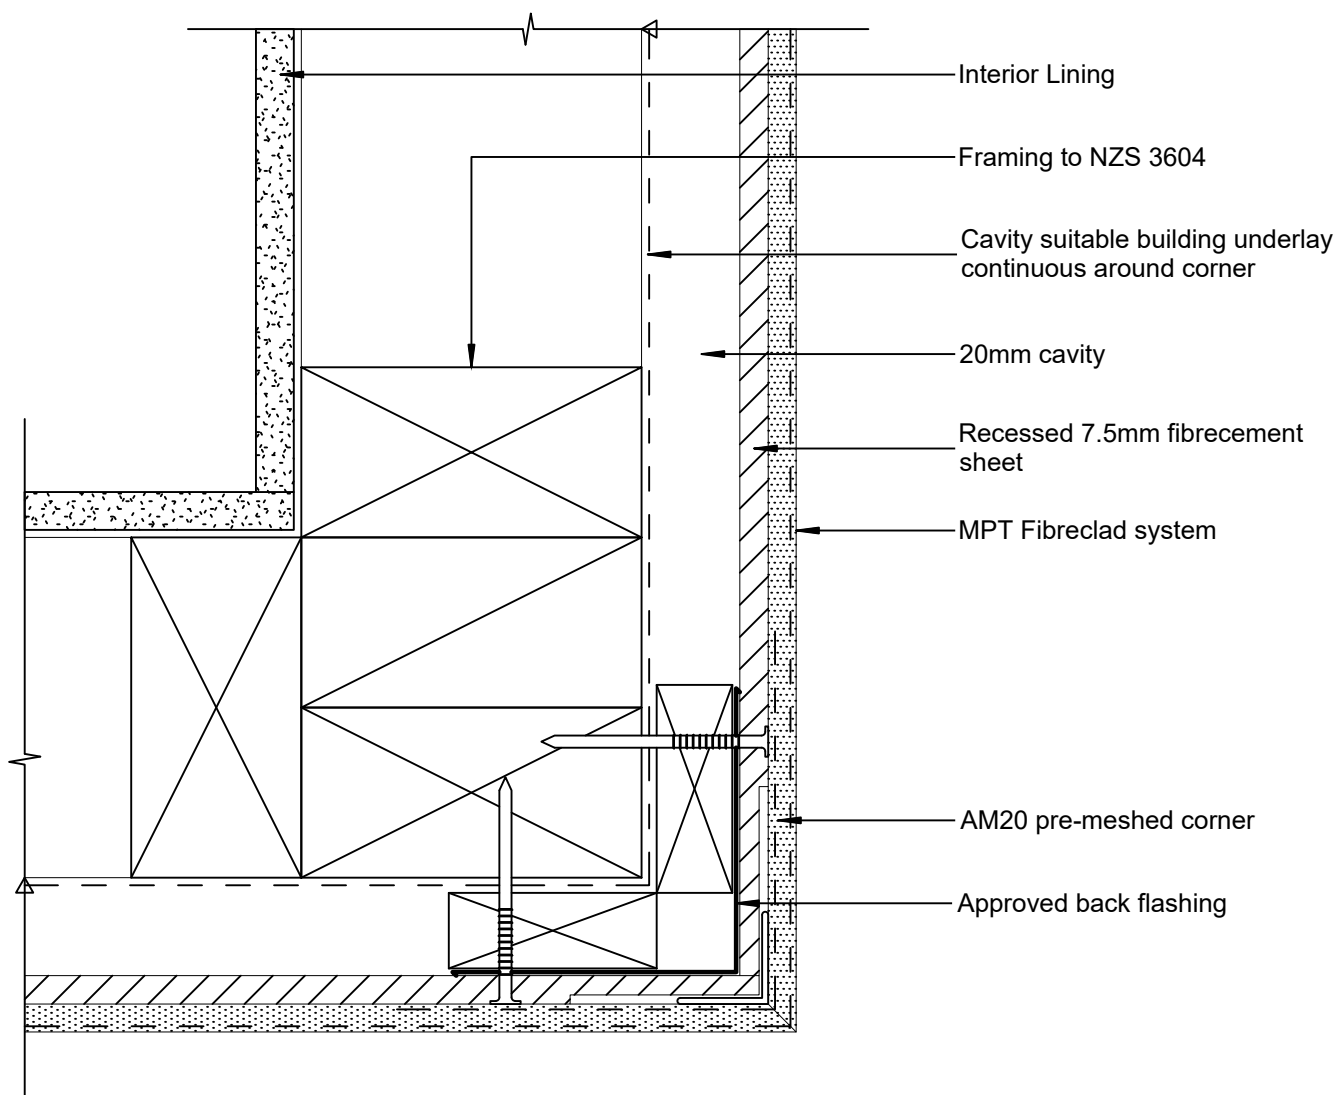
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Date: June 2019

Scale: 1 : 2 @ A4

Revision: 2

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MPT Fibreclad System Corner - External Square

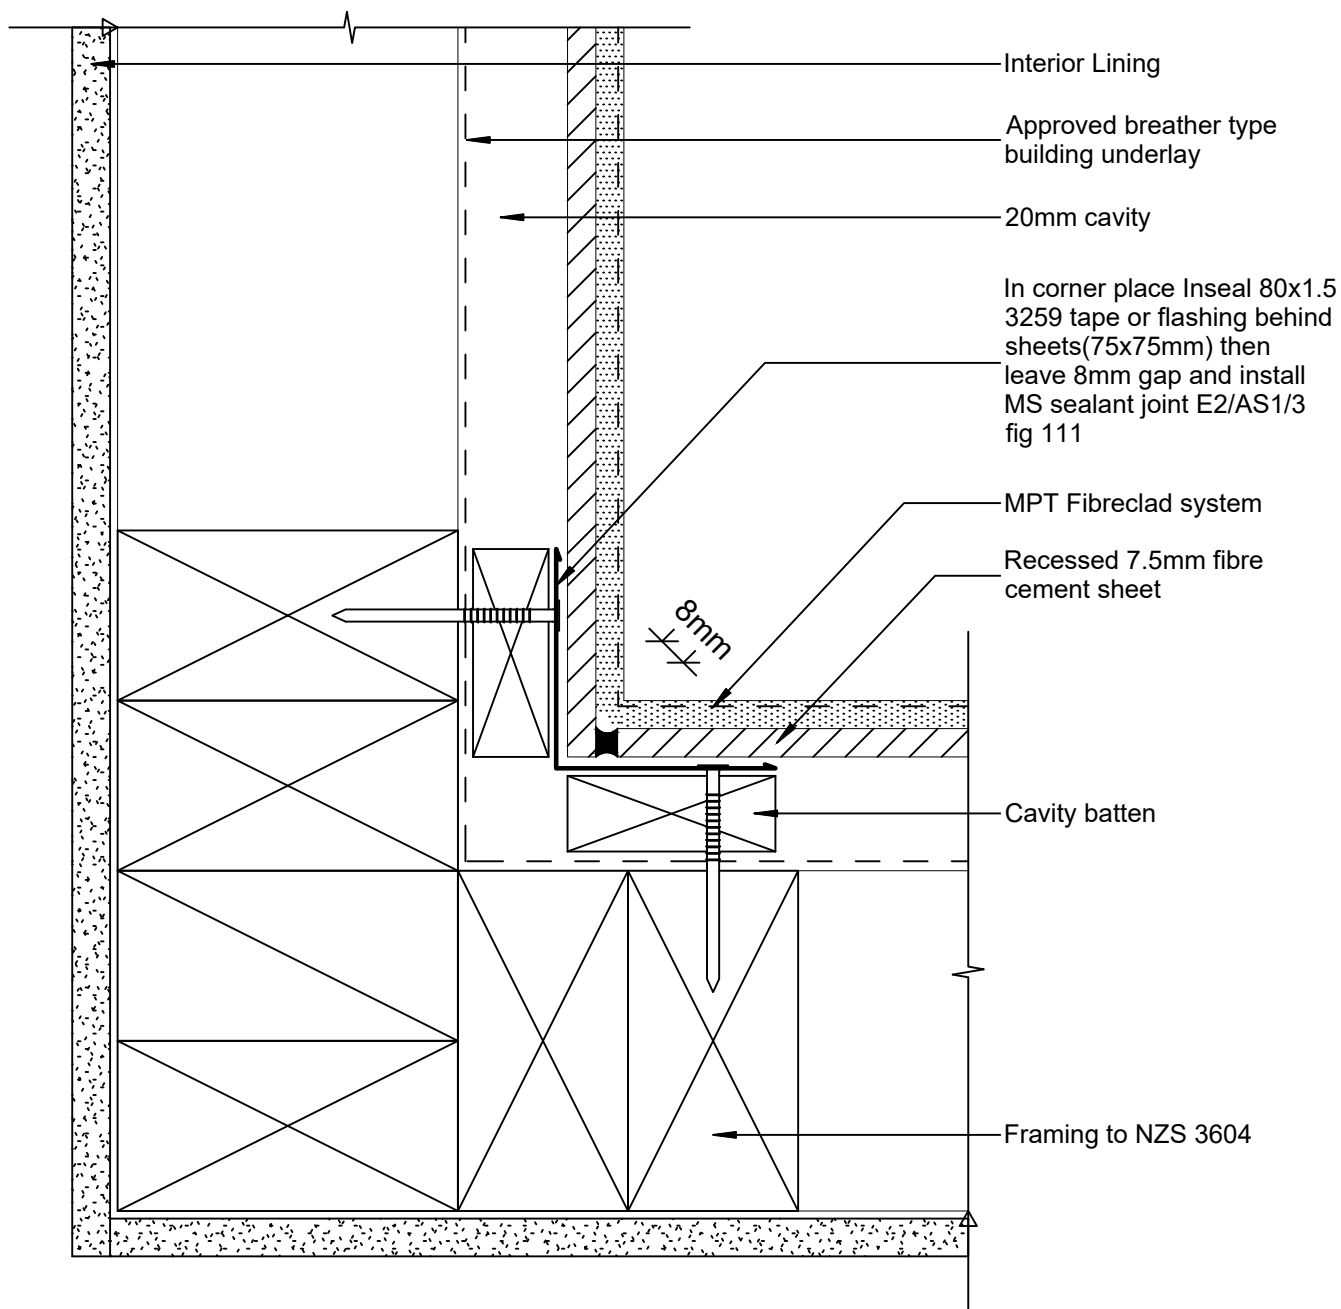
Reference: MPT_F021

Date: June 2019

Scale: 1 : 2 @ A4

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MPT Fibreclad System

Corner - Internal Square

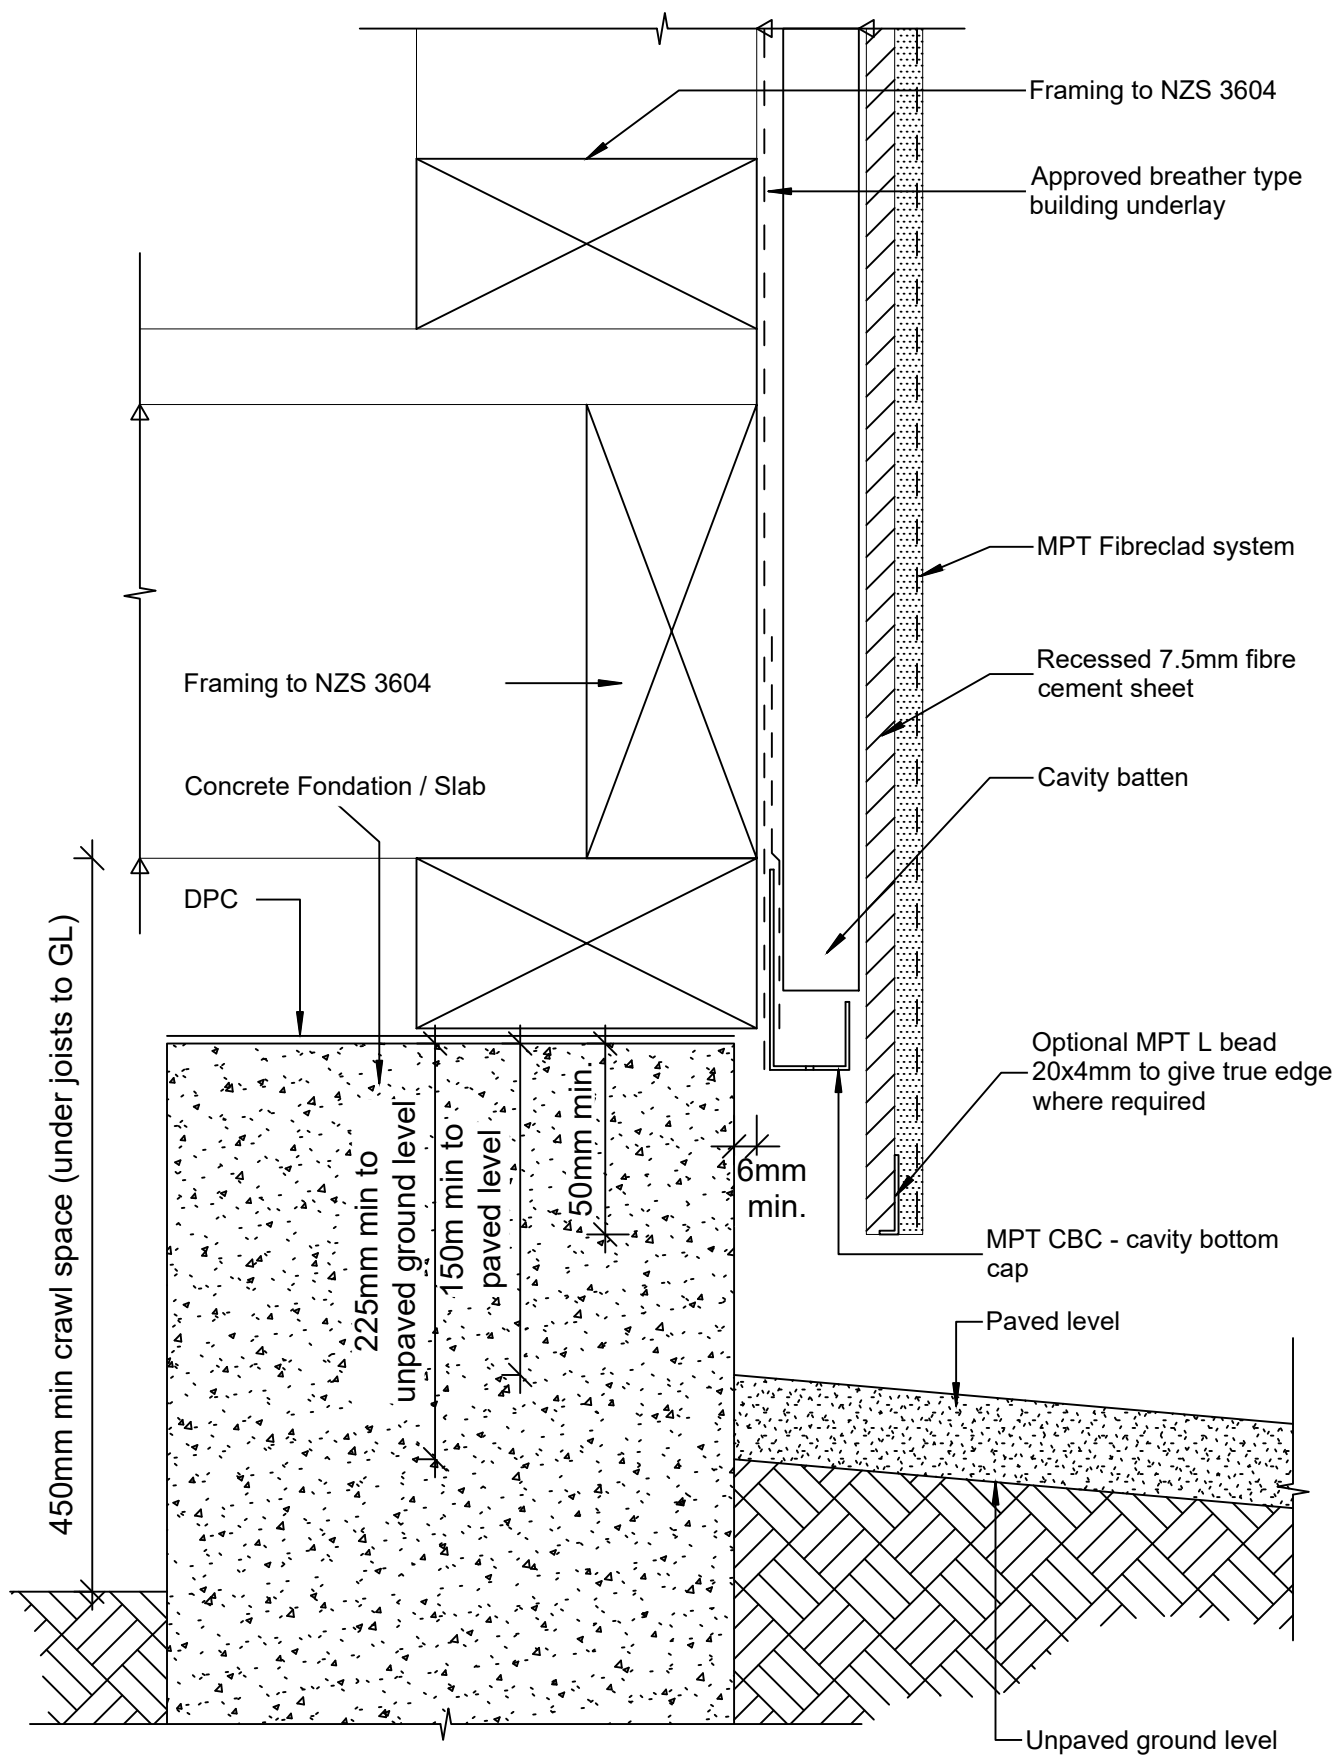
Reference: MPT_F022

Date: June 2019

Scale: 1 : 2 @ A4

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MPT Fibreclad System

Foundation - Concrete Base

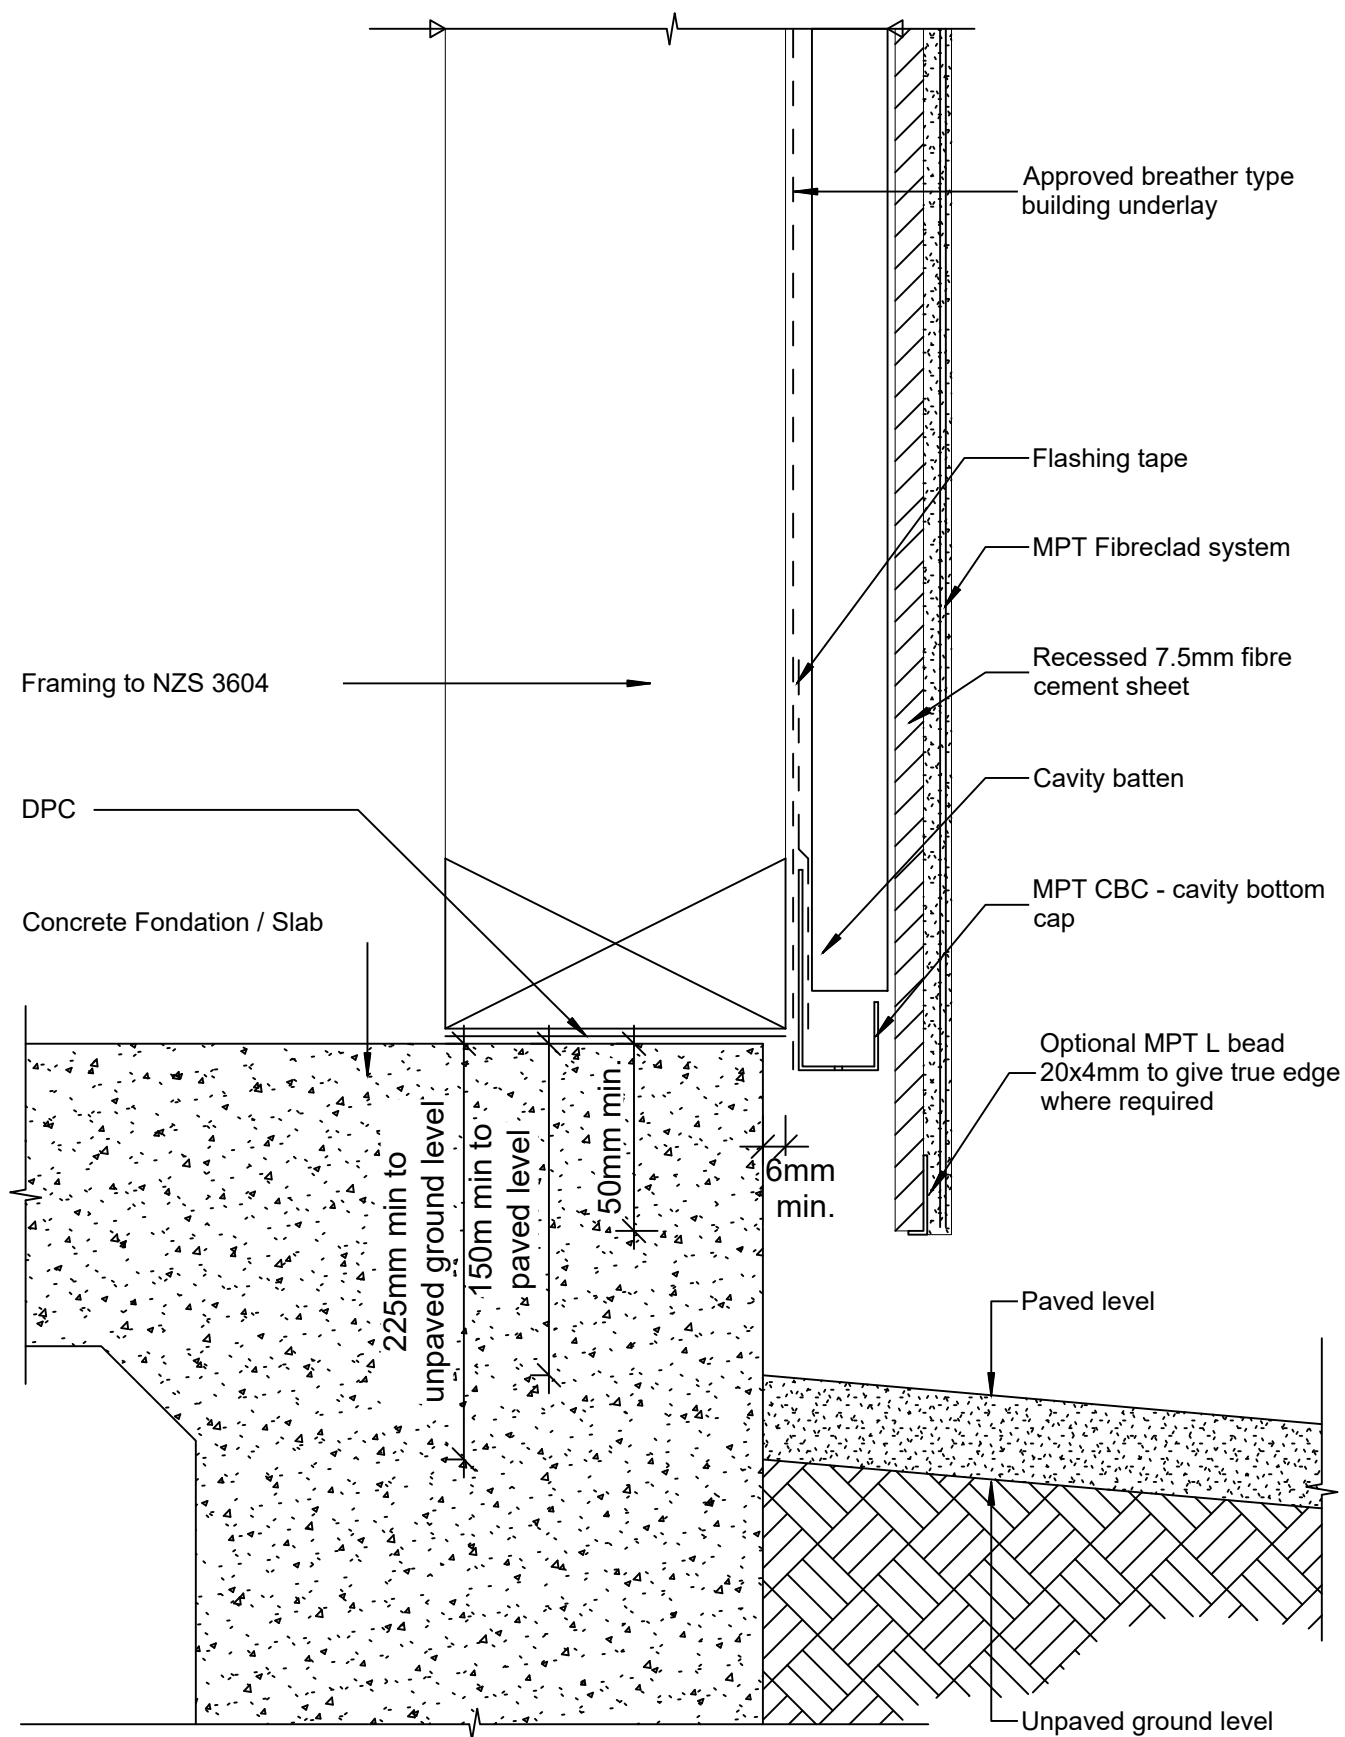
Reference: MPT_F031

Date: June 2019

Scale: 1 : 2 @ A4

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MPT Fibreclad System

Foundation - Concrete Slab Base

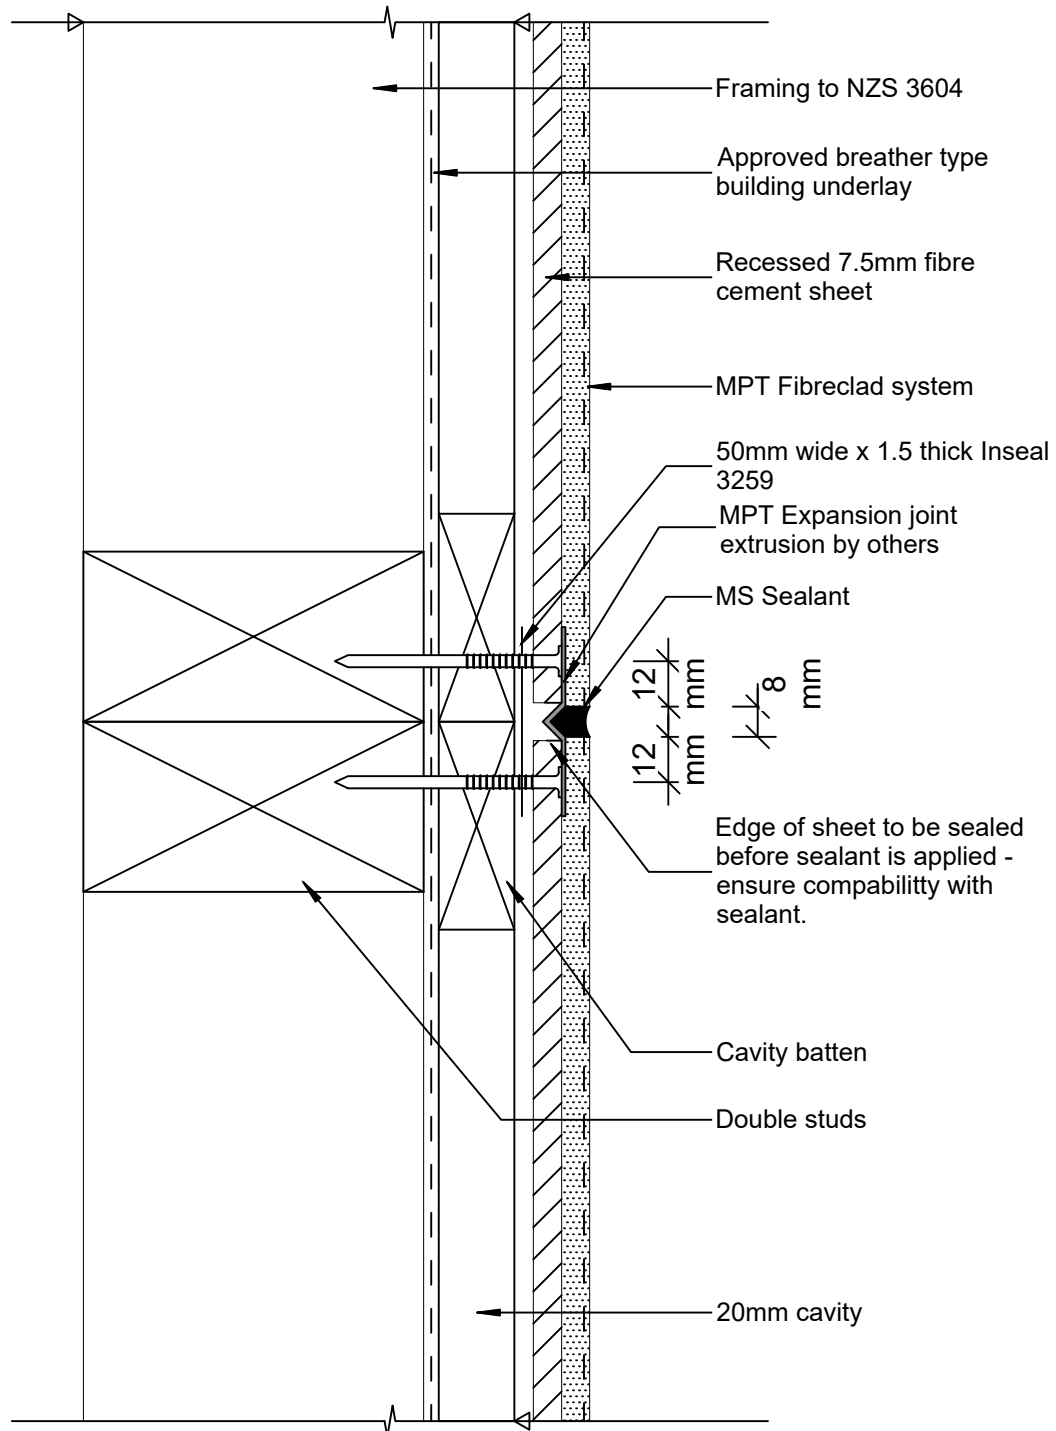
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Date: June 2019

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MPT Fibreclad System

Joint - Vertical Expansion Joint

Reference: MPT_F041

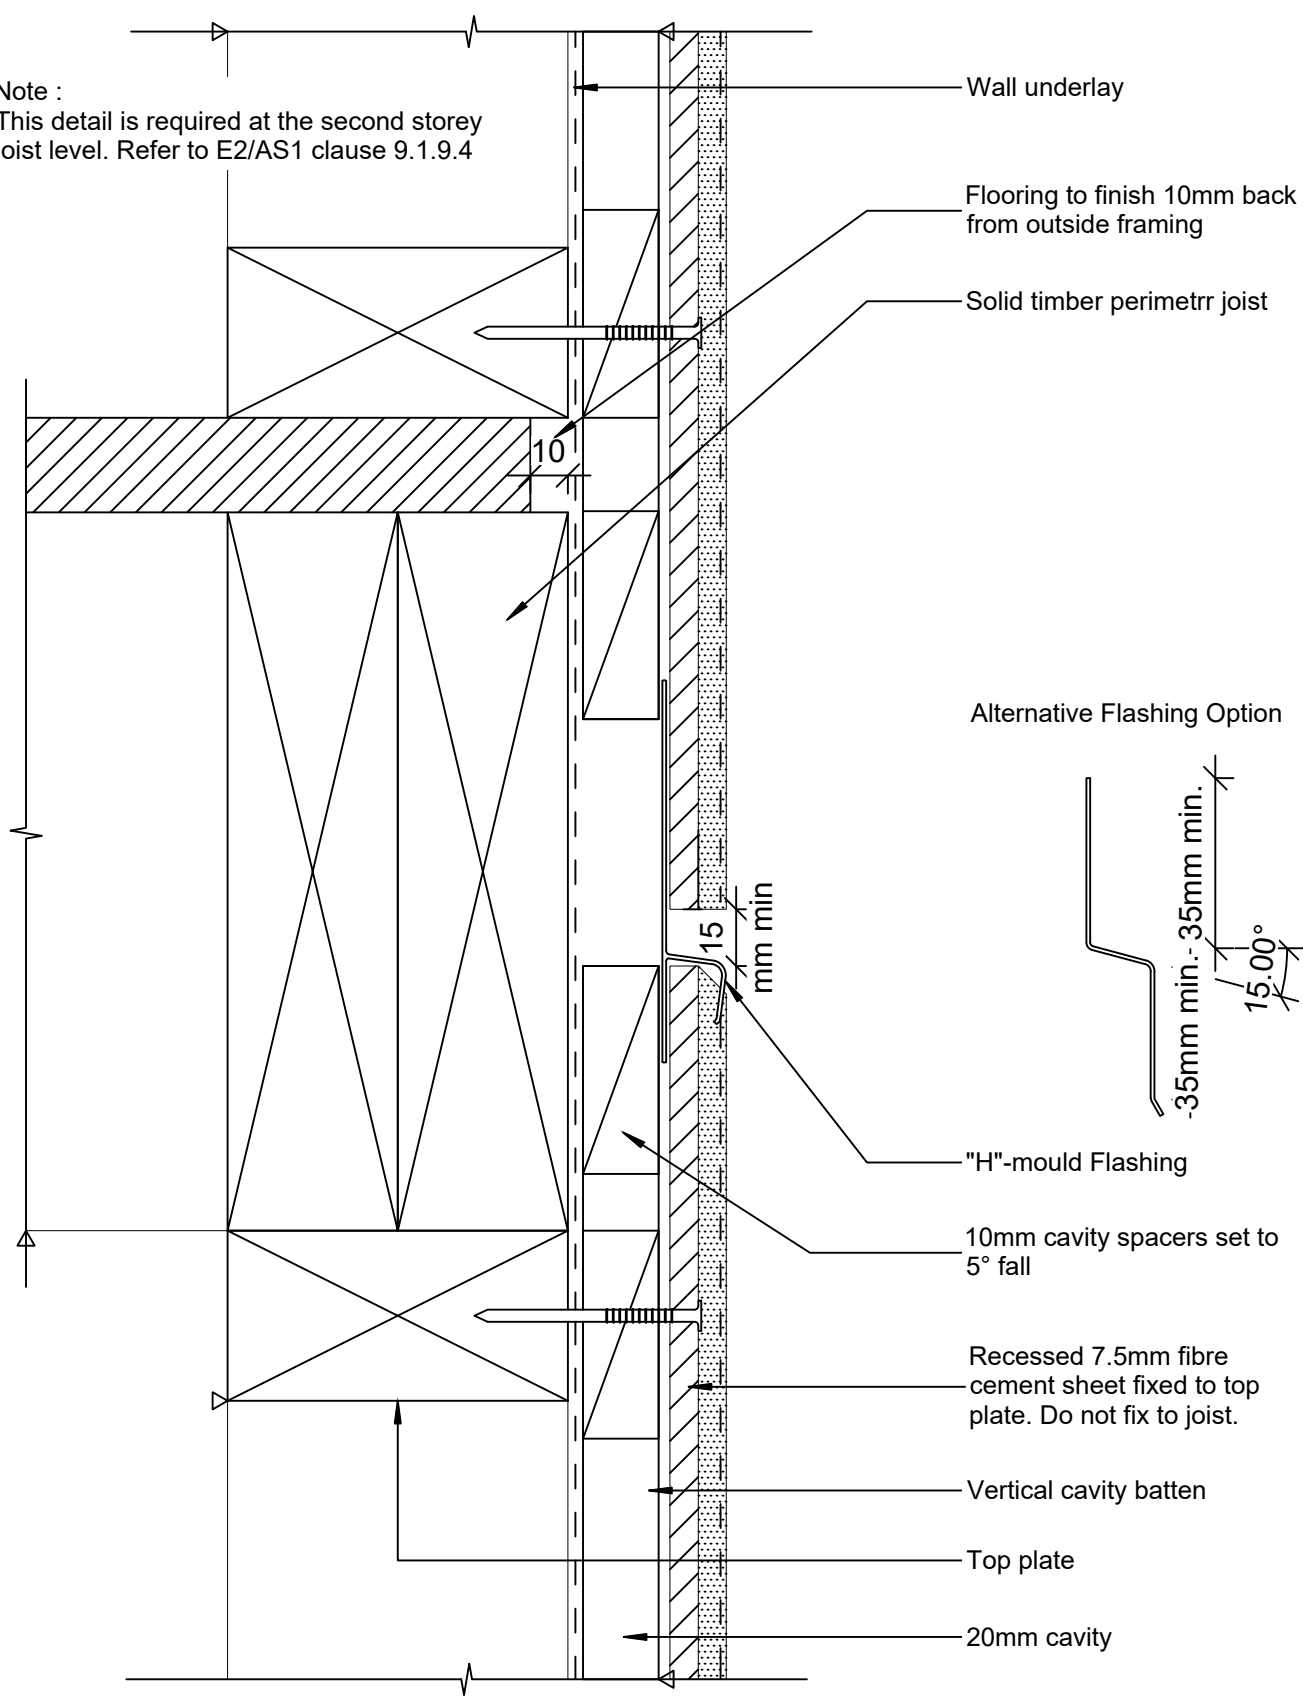
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Note :
 This detail is required at the second storey joist level. Refer to E2/AS1 clause 9.1.9.4



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MPT Fibreclad System

Joint - Horizontal Expansion Joint - 2 Storeys or Less

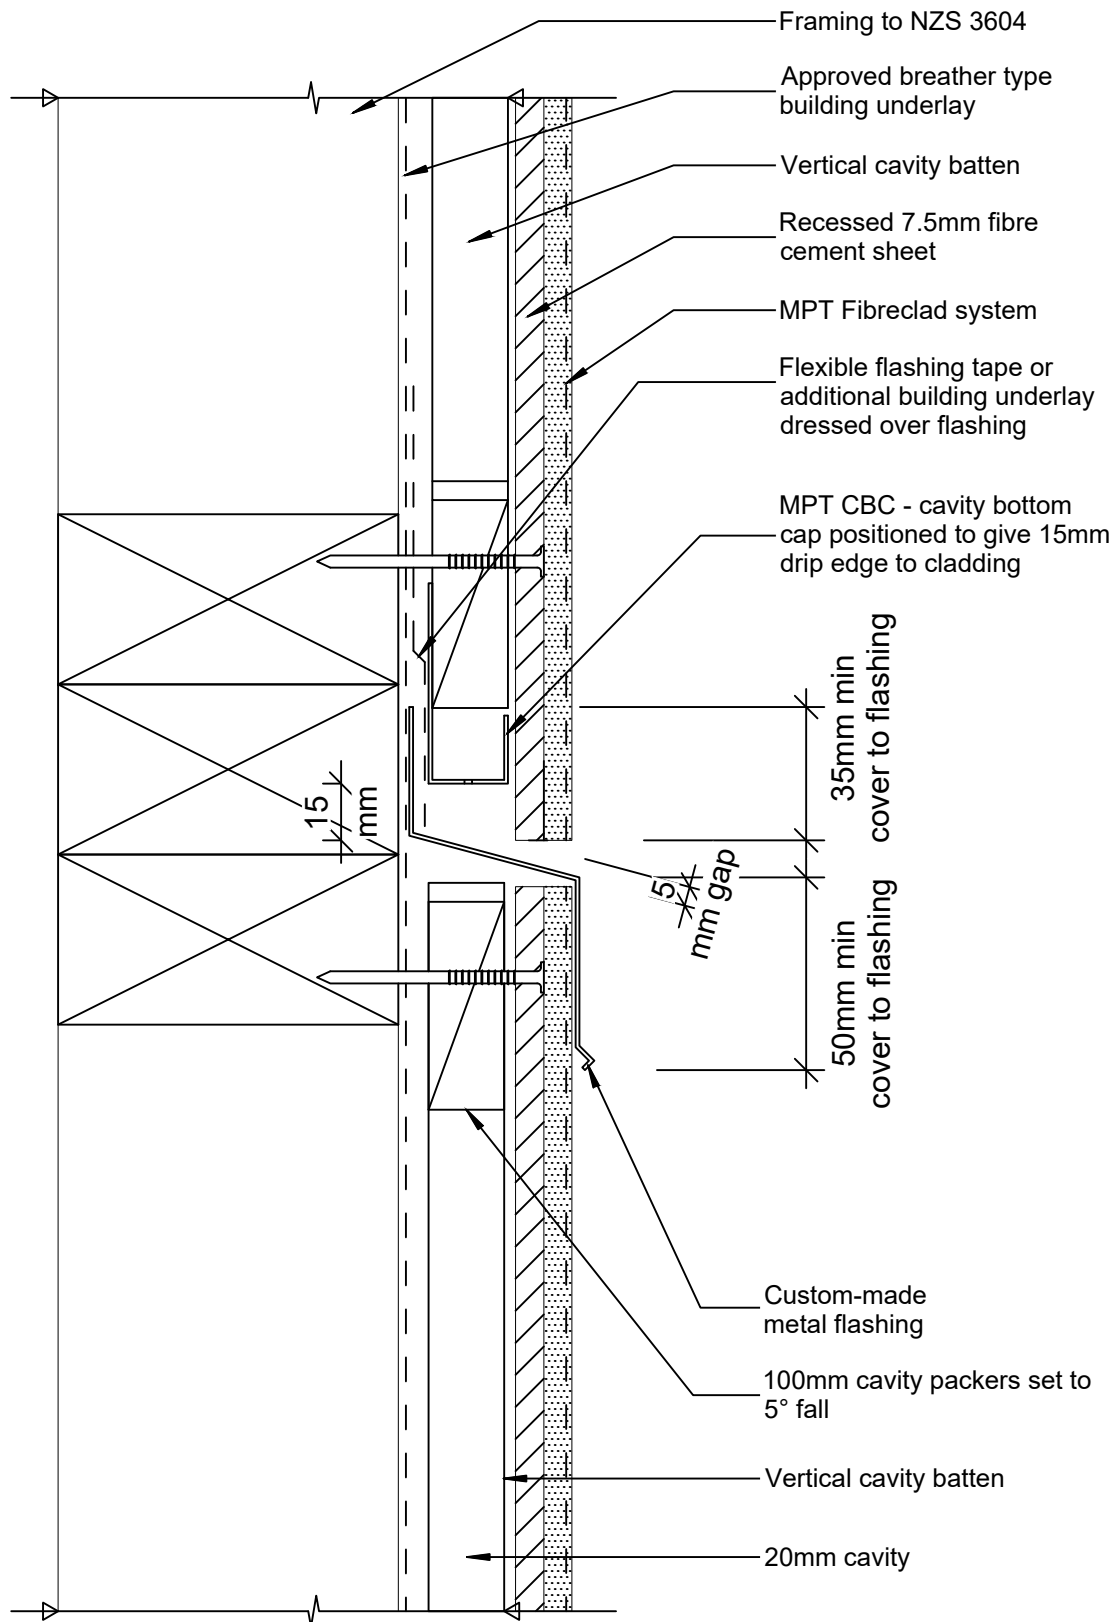
Reference: MPT_F042

Date: June 2019

Scale: 1 : 2 @ A4

Revision: 2

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MPT Fibreclad System

Joint - Horizontal Expansion Joint - Greater than 2
Storeys

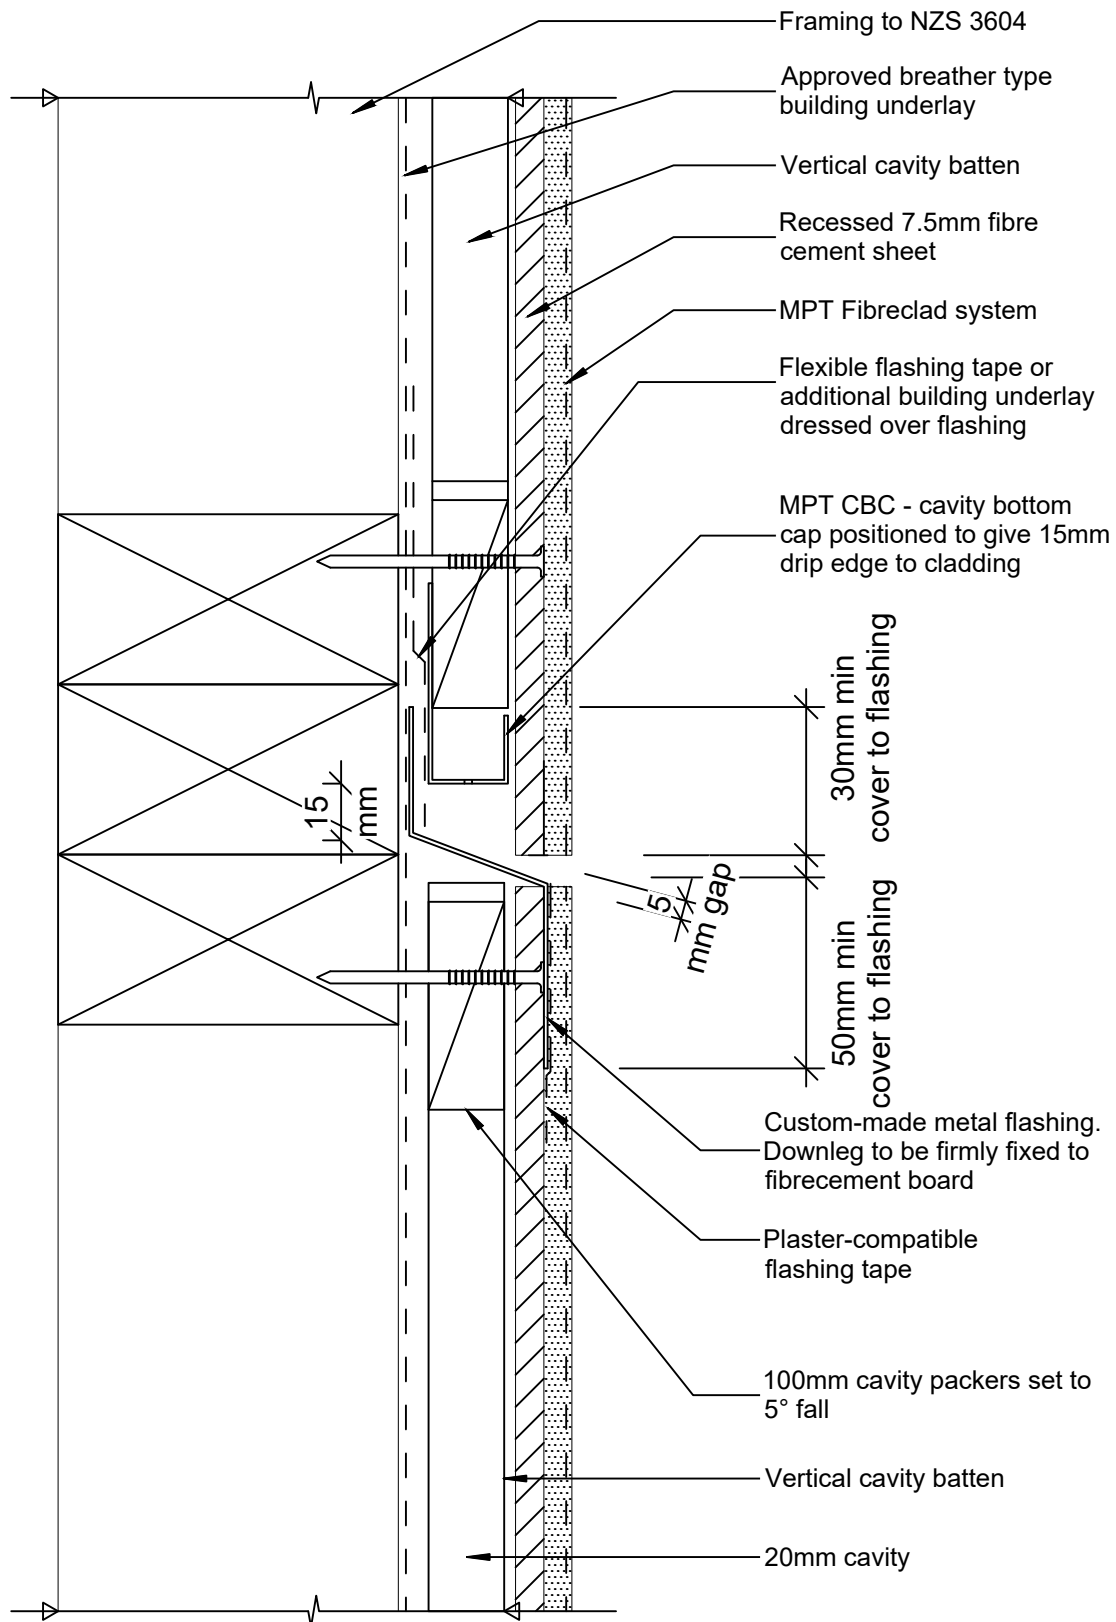
Reference: MPT_F043

Date: June 2019

Scale: 1 : 2 @ A4

Revision: 2

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MPT Fibreclad System

Joint - Horizontal Expansion Joint - Greater than 2
Storeys - Option 2

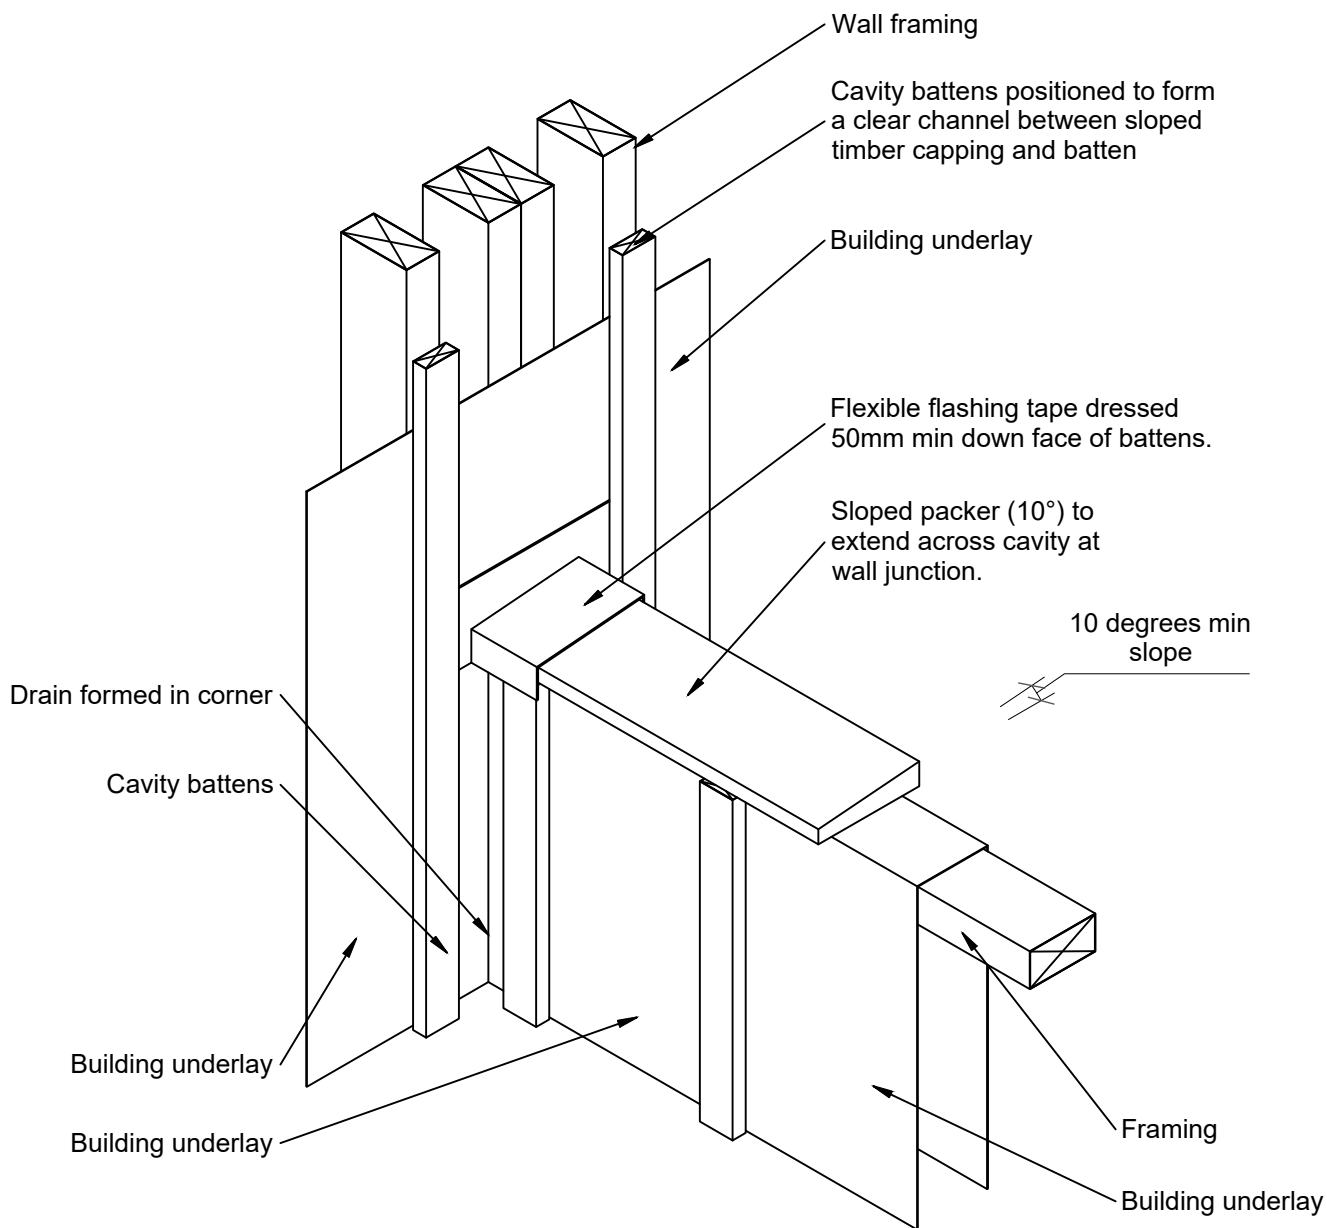
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Date: June 2019

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Stage 1

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MPT Fibreclad System Junction - Parapet Balustrade Wall Secondary Flashing

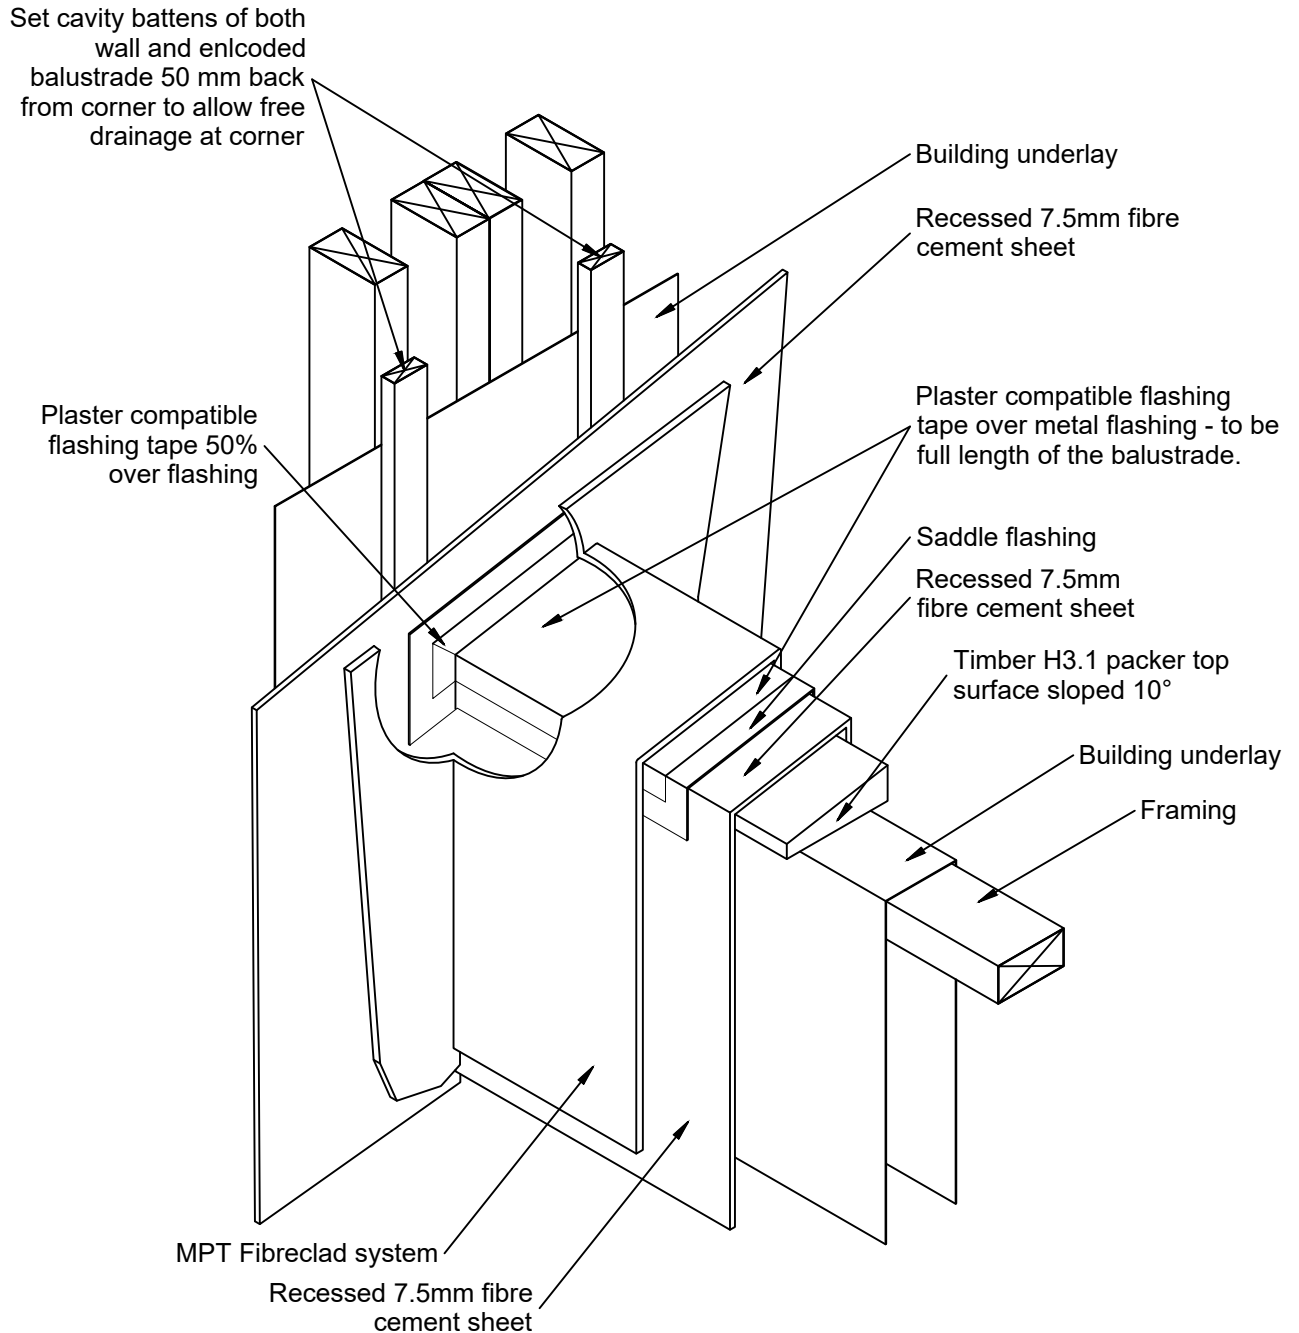
Reference: MPT_F051

Date: June 2019

Scale: 1 : 10 @ A4

Revision: 2

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Note:
This detail does not apply to parapets.

Stage 2

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MPT Fibreclad System Junction - Parapet Balustrade Wall Secondary Flashing

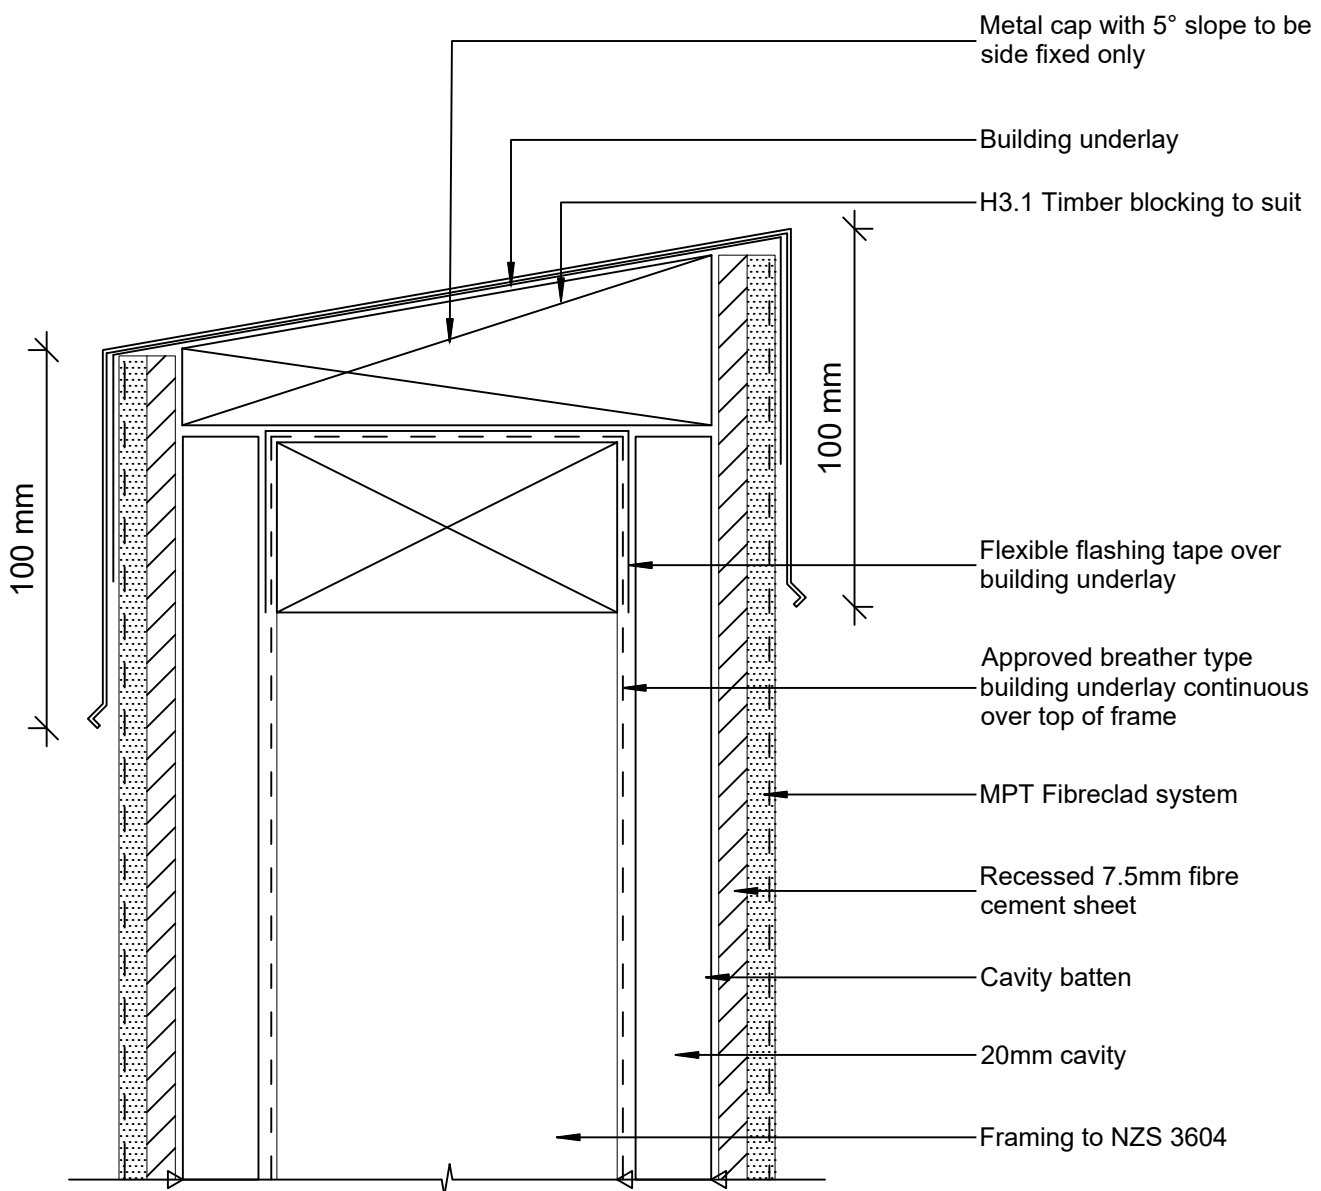
Reference: MPT_F052

Date: June 2019

Scale: 1 : 10 @ A4

Revision: 2

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Notes:

- Fixings through top of parapet are not permitted.
- Ensure parapet is temporarily waterproofed prior to plastering.
- Install metal saddle flashing at wall junction.
- Install metal capping to all roof parapets.
- Metal cap excluding dripedge must overlap board by 100mm minimum.
- Refer to NZBC E2/AS1 Table 7 for flashing cover dimensions.

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MPT Fibreclad System

Parapet - Flat

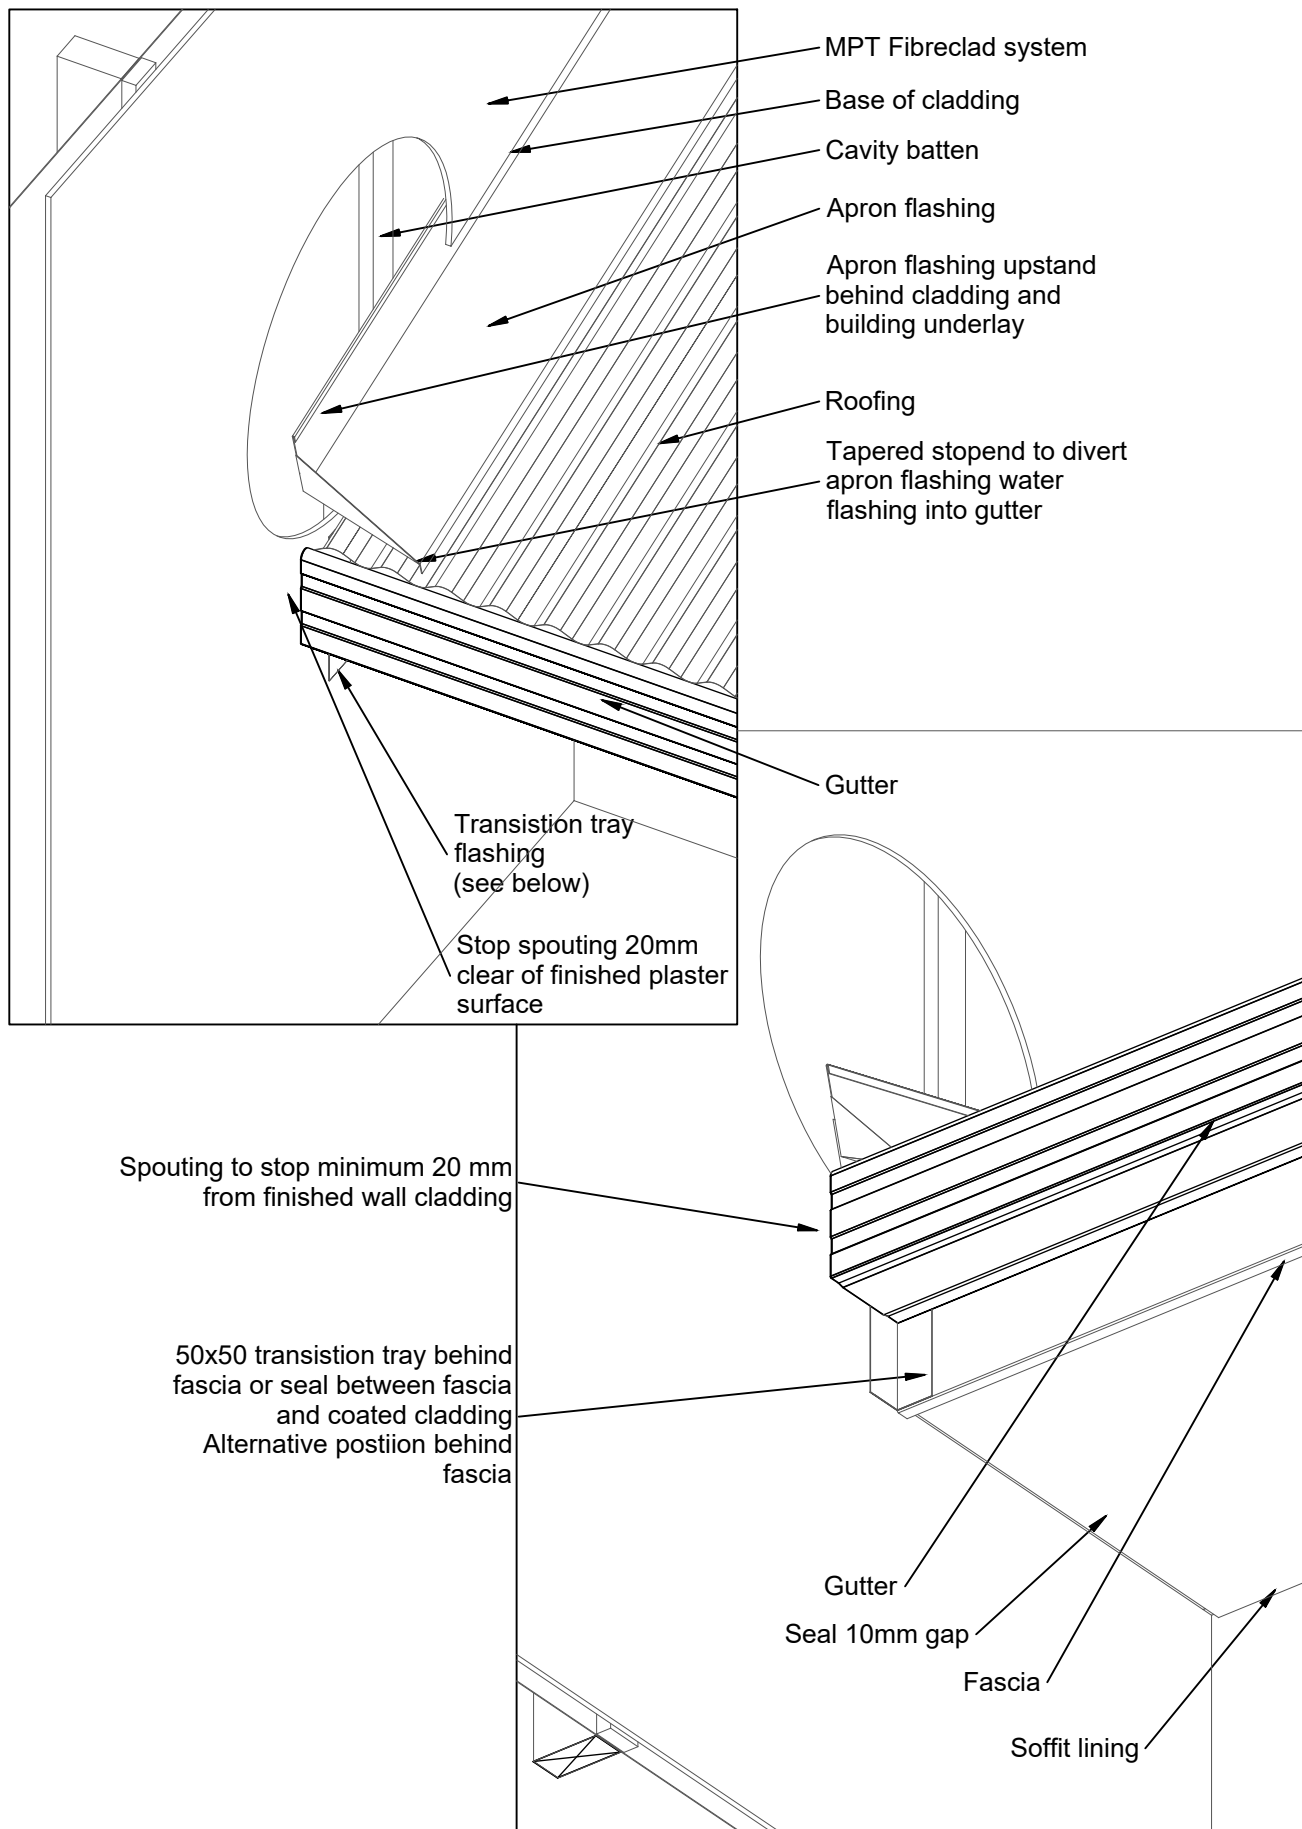
Reference: MPT_F053

Date: June 2019

Scale: 1 : 2 @ A4

Revision: 2

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MPT Fibreclad System

Junction - Stopend Flashing - Roof to Wall

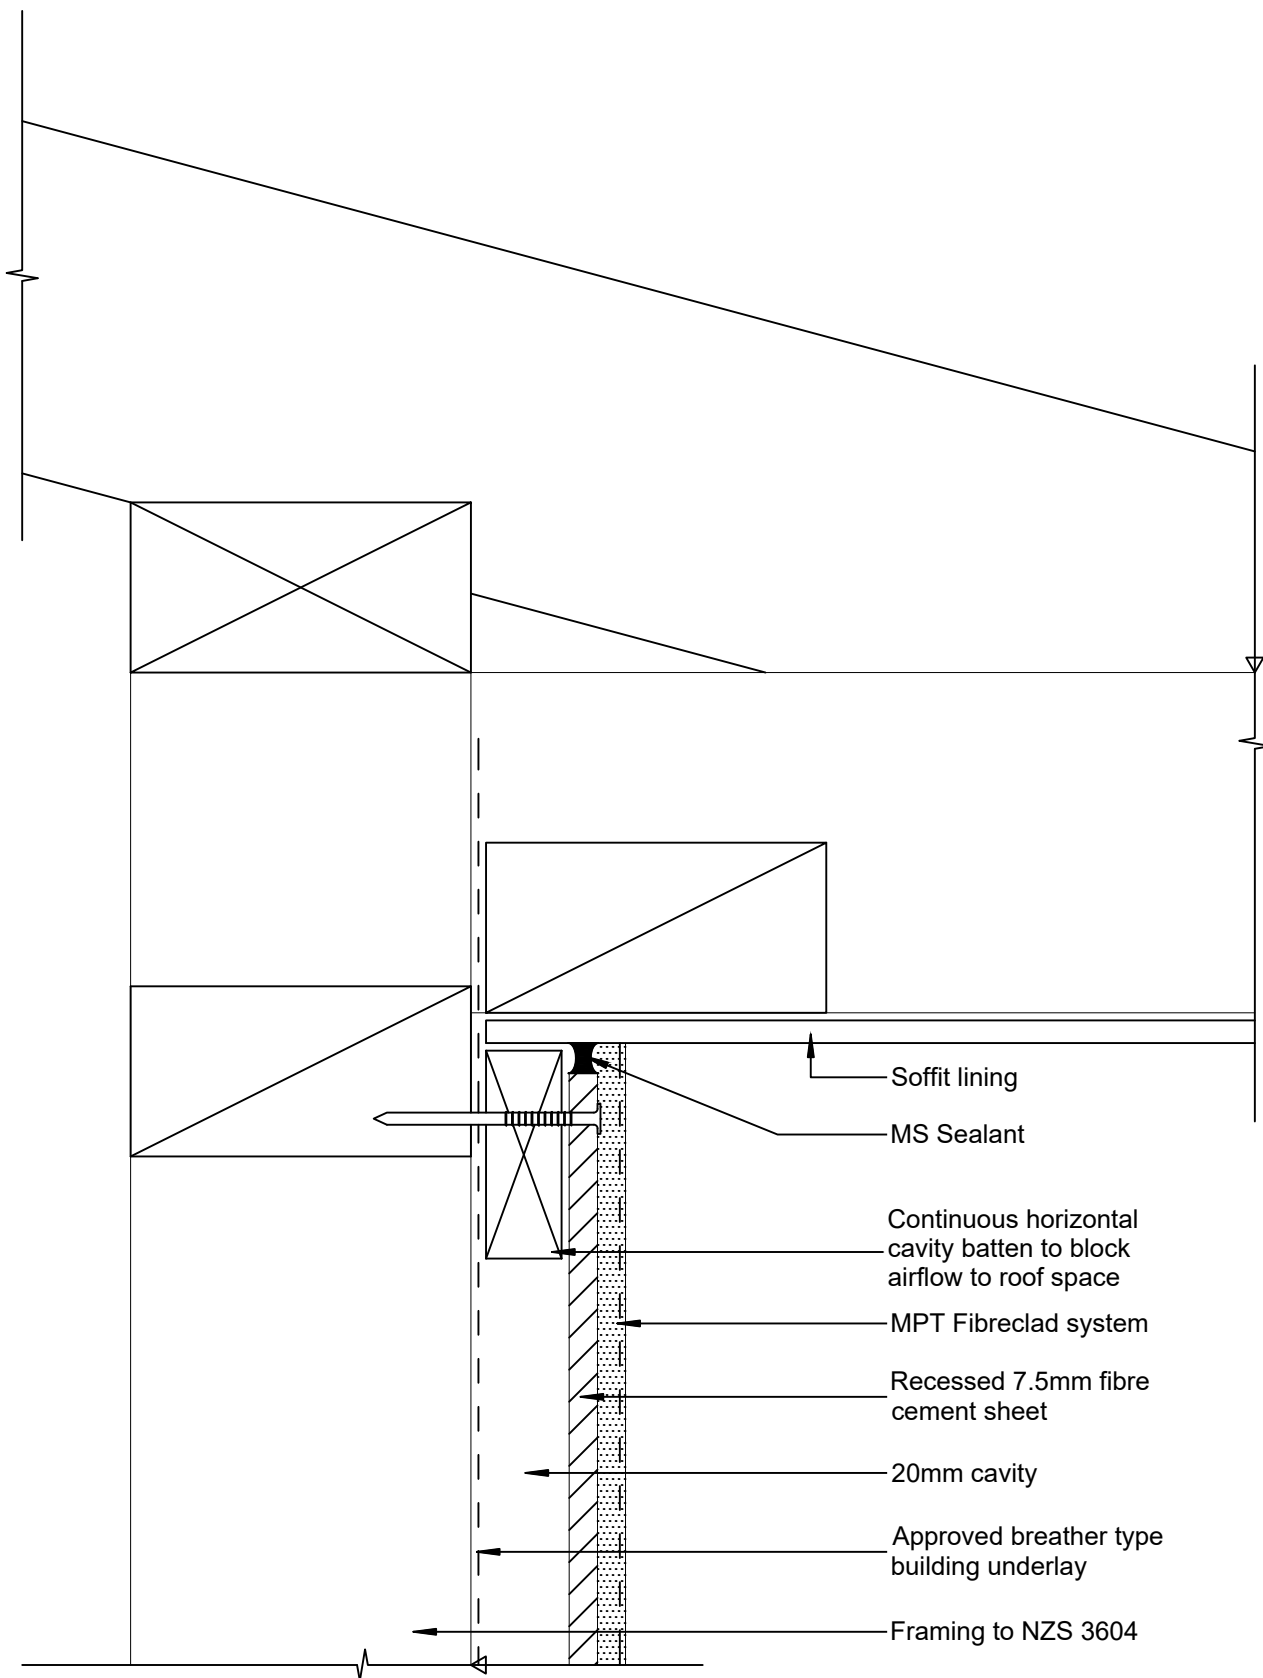
Reference: MPT_F061

Date: June 2019

Scale: 1 : 10 @ A4

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MPT Fibreclad System

Soffit - Horizontal Detail

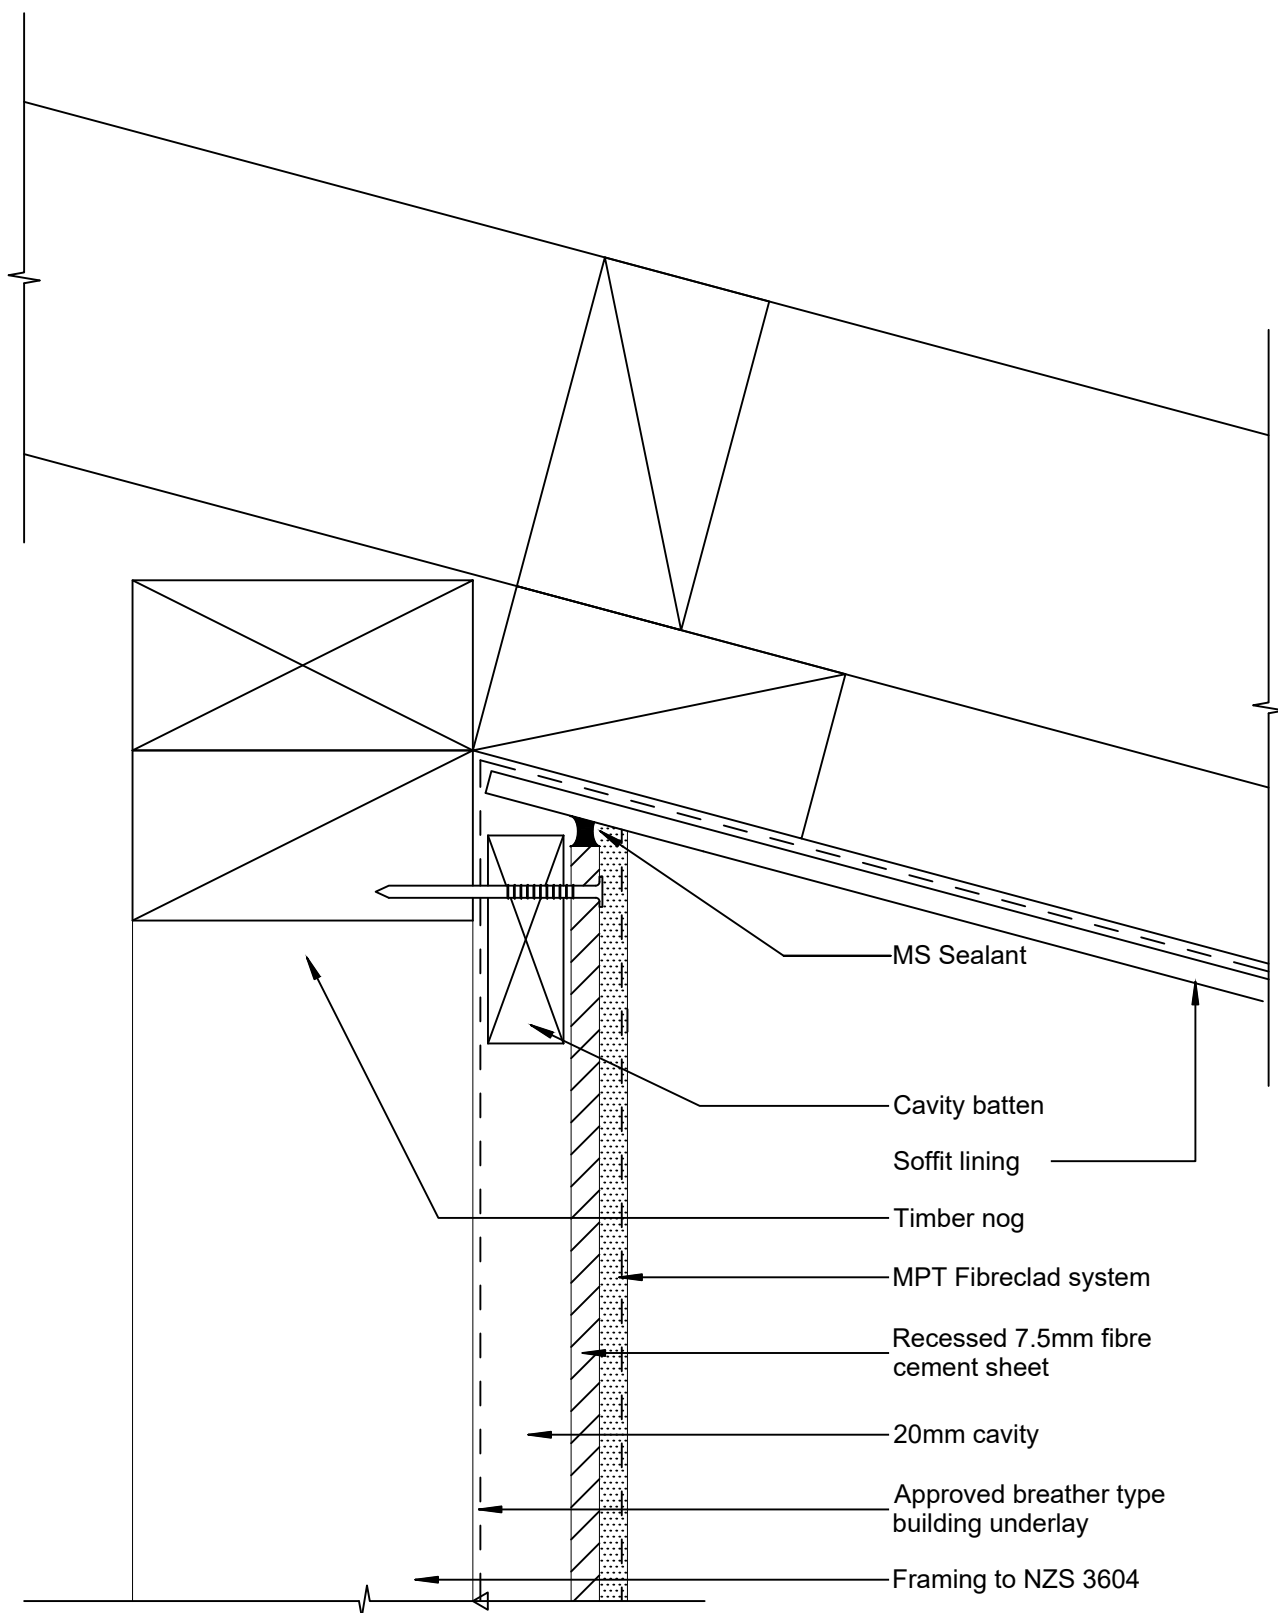
Reference: MPT_F071

Date: June 2019

Scale: 1 : 2 @ A4

Revision: 2

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MPT Fibreclad System

Soffit - Slopped Detail

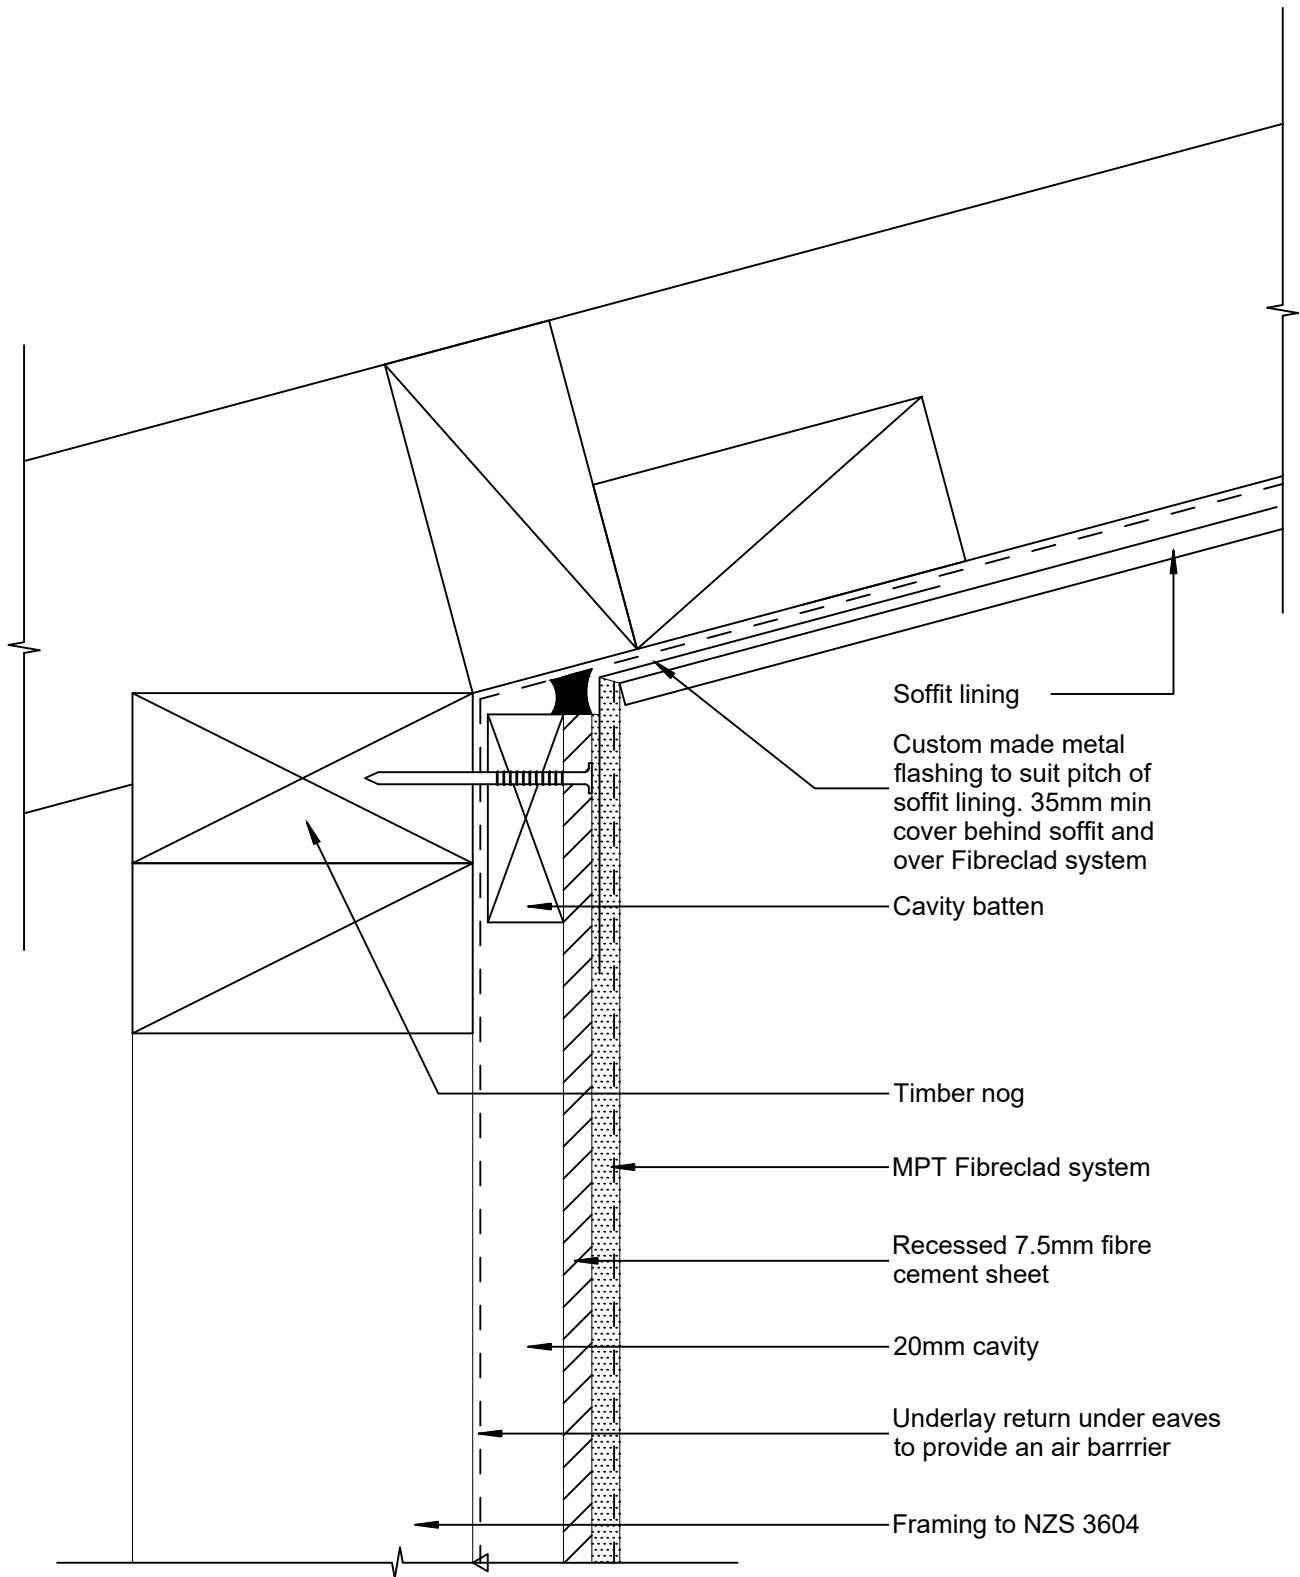
Reference: MPT_F072

Date: June 2019

Scale: 1 : 2 @ A4

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MPT Fibreclad System

Soffit - Reverse Raked

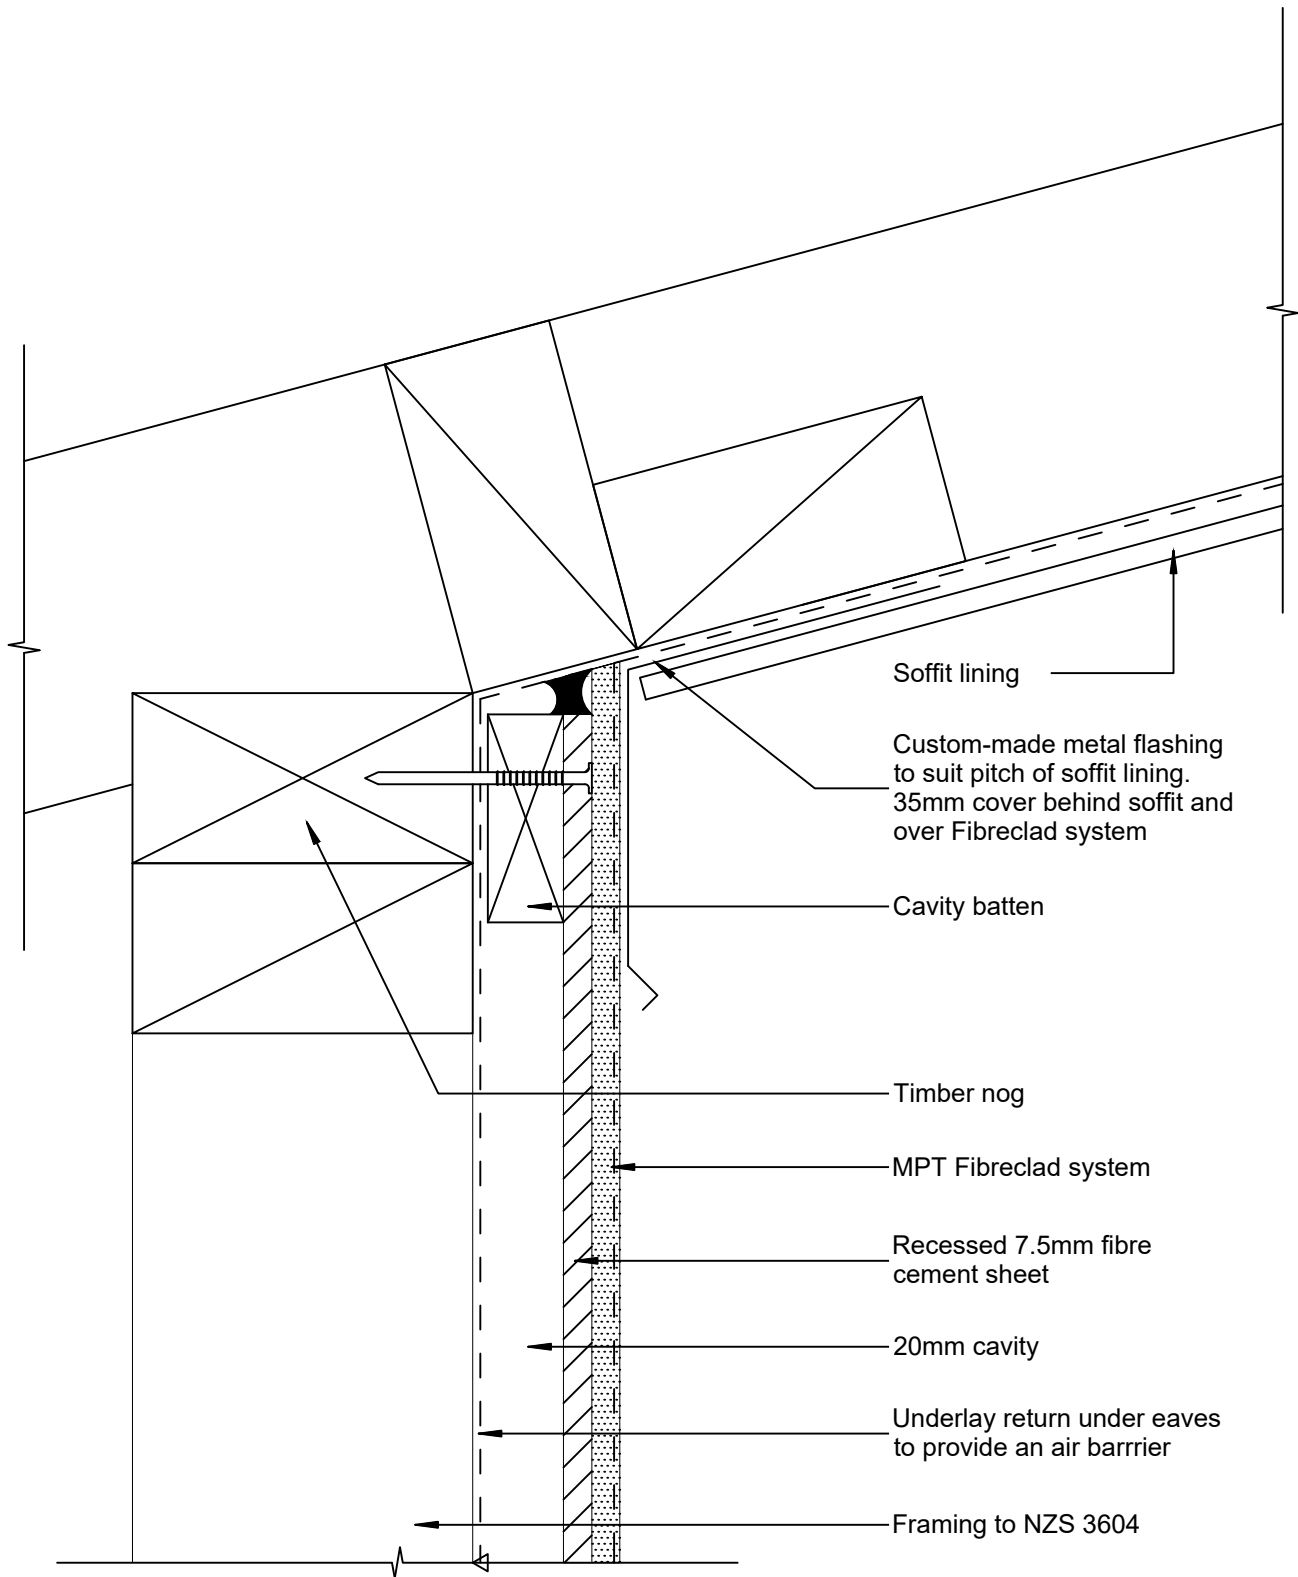
Reference: MPT_F073

Date: June 2019

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Revision: 2

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MPT Fibreclad System

Soffit - Reverse Raked Alternative Option

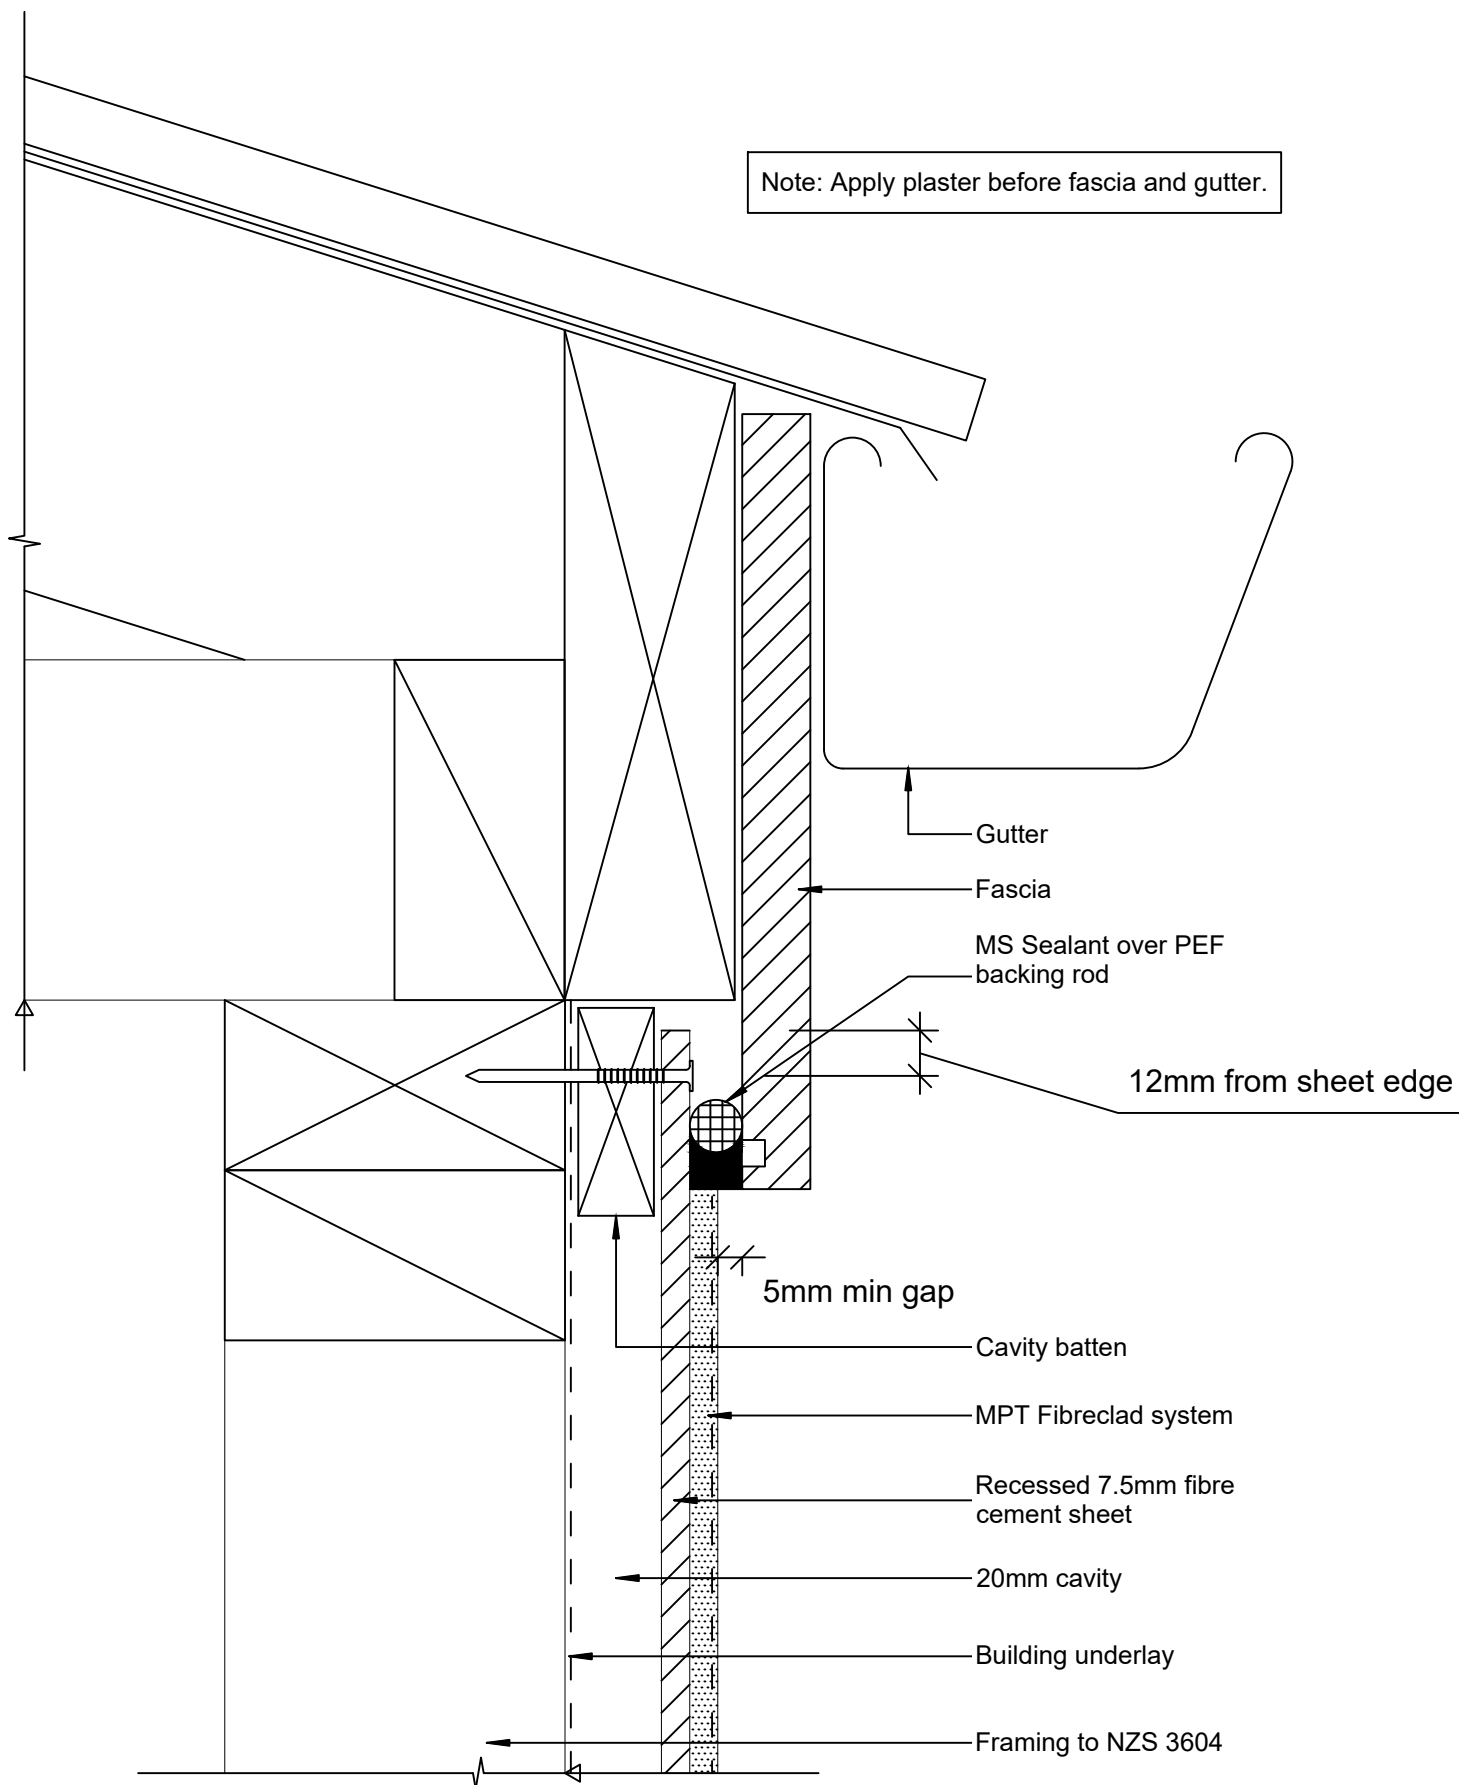
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Soffit - Flush Eaves Gutter

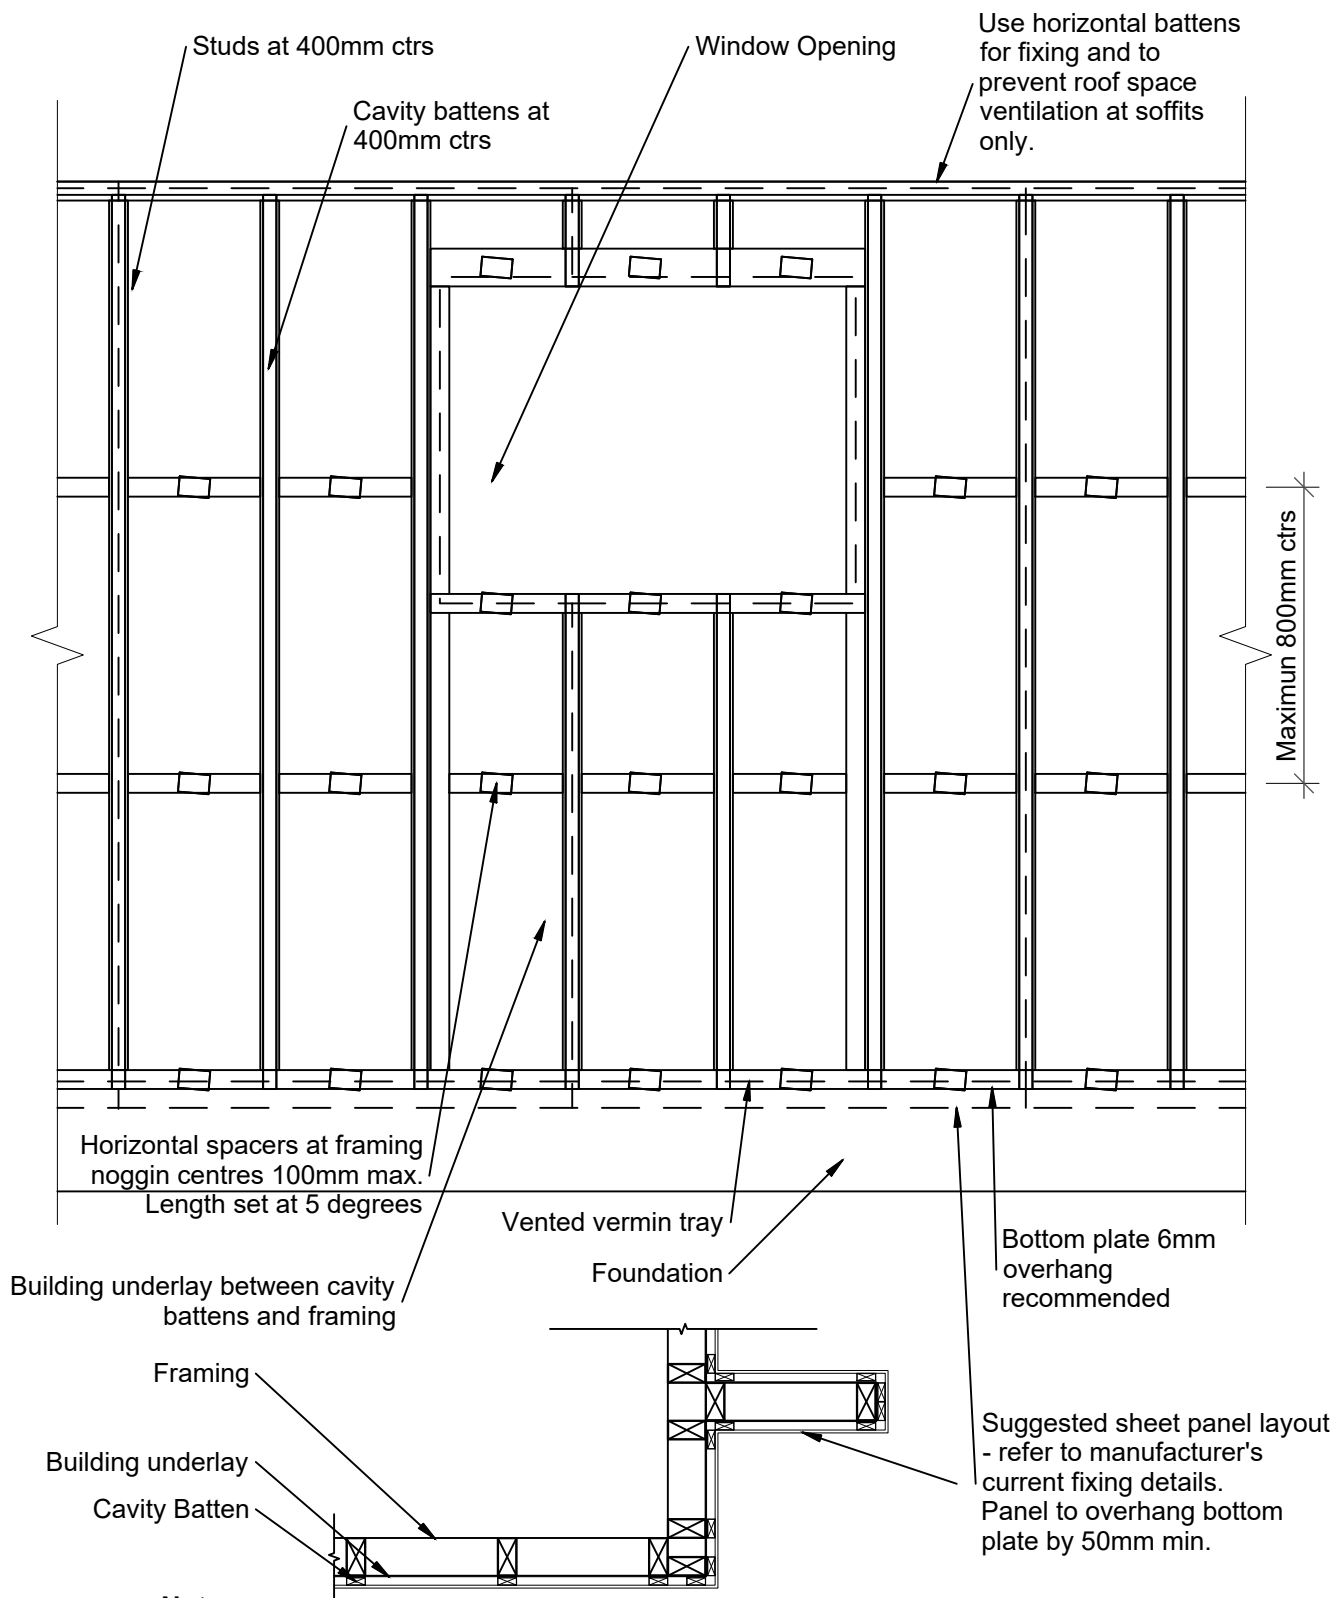
Reference: MPT_F075

Date: June 2019

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Notes:

- Ensure batten layout is in accordance with board manufacturers specifications.
- Additional battens may be required at window framing, avoid battens under jambs.
- Horizontal spacers at framing nogs centres 100mm max - length set at 5 degrees.
- Timber battens to be H3.1 treated as per NZS 3602.
- Air flow to be blocked at soffits to prevent cross or through ventilation.
- Gables to be lined or have an air barrier wrap installed.

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MPT Fibreclad System

Wall - Framing Layout Timber Framing With Battens 400

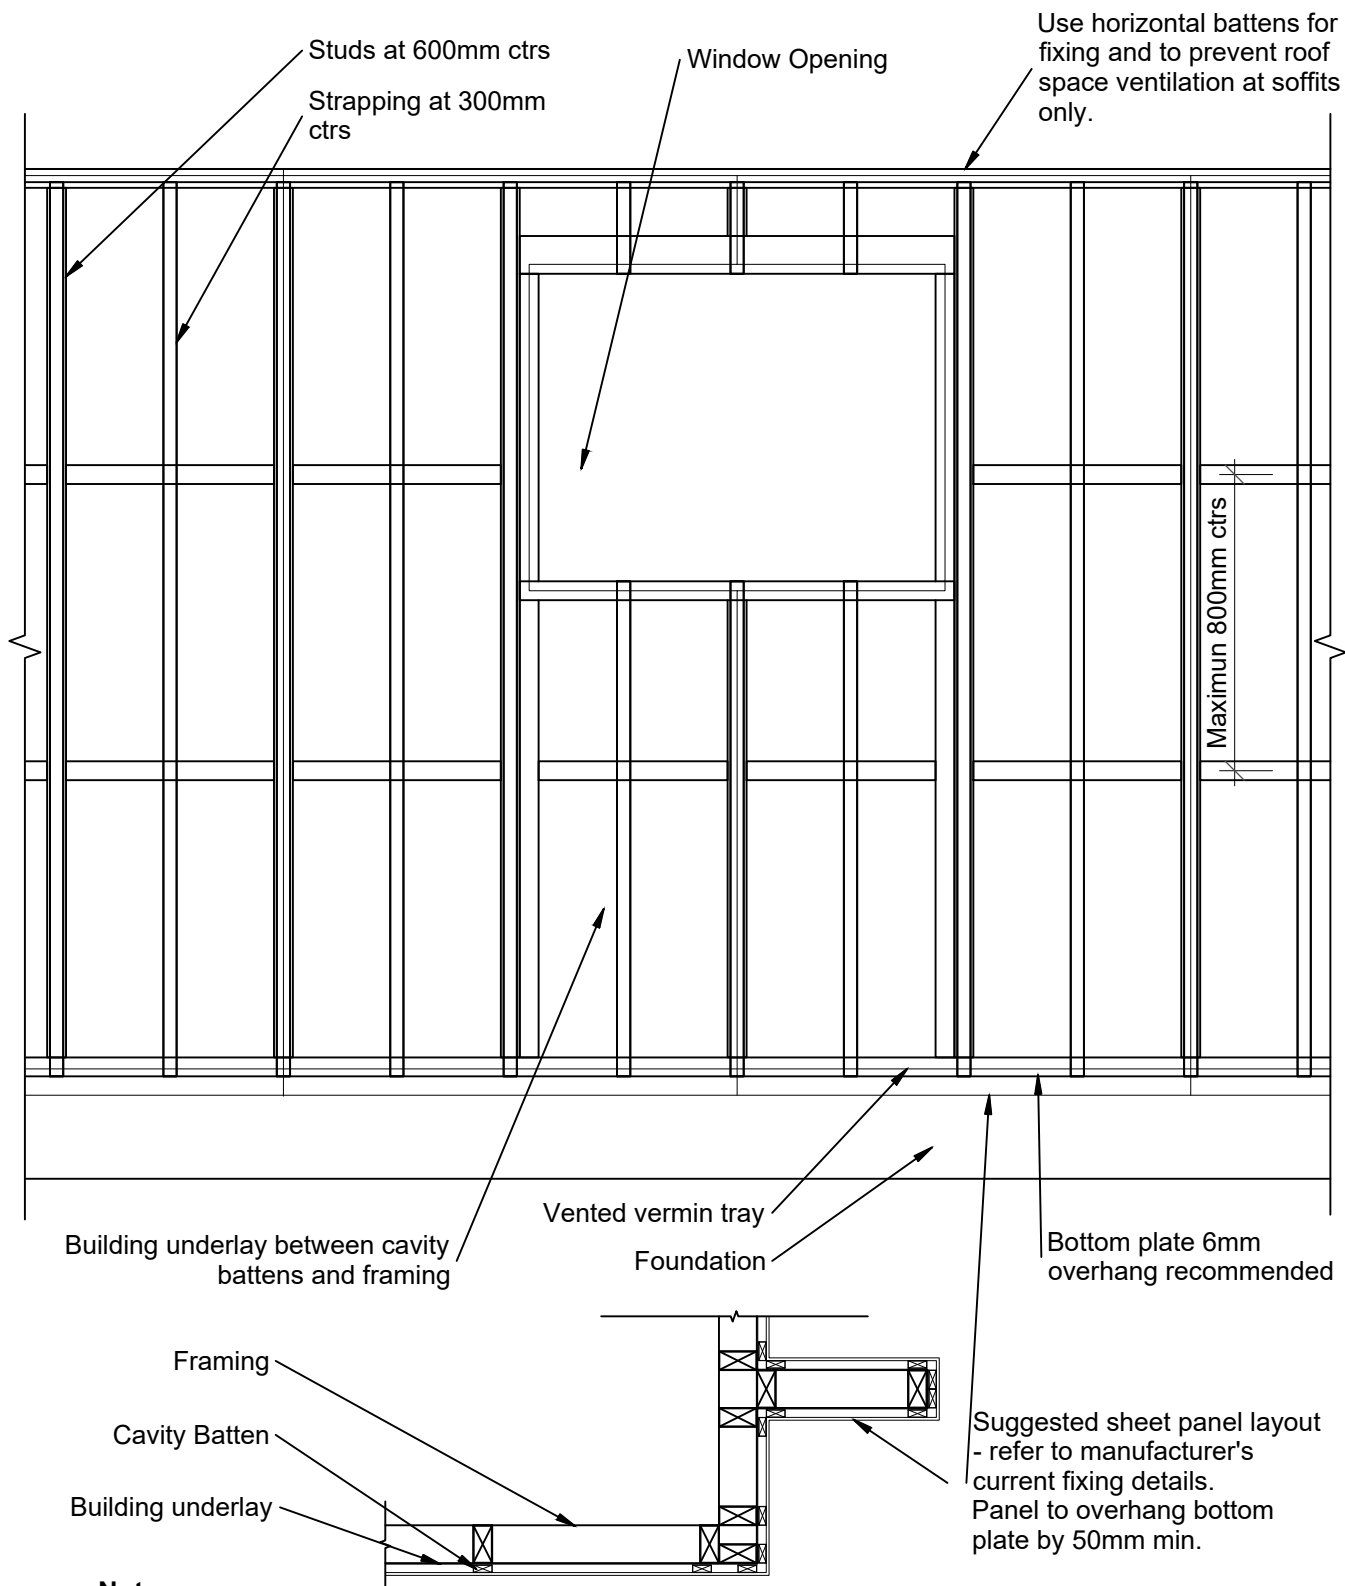
Reference: MPT_F081

Date: June 2019

Scale: 1 : 20 @ A4

Revision: 2

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Notes:

- Ensure batten layout is in accordance with board manufacturers specifications.
- Additional battens may be required at window framing, avoid battens under jambs.
- Timber battens to be treated H3.1 as per NZS 3602.
- Air flow to be blocked at soffits to prevent cross or through ventilation.
- Gables to be lined or have an air barrier wrap installed.

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MPT Fibreclad System

Wall - Framing Layout Timber Framing With Battens 600

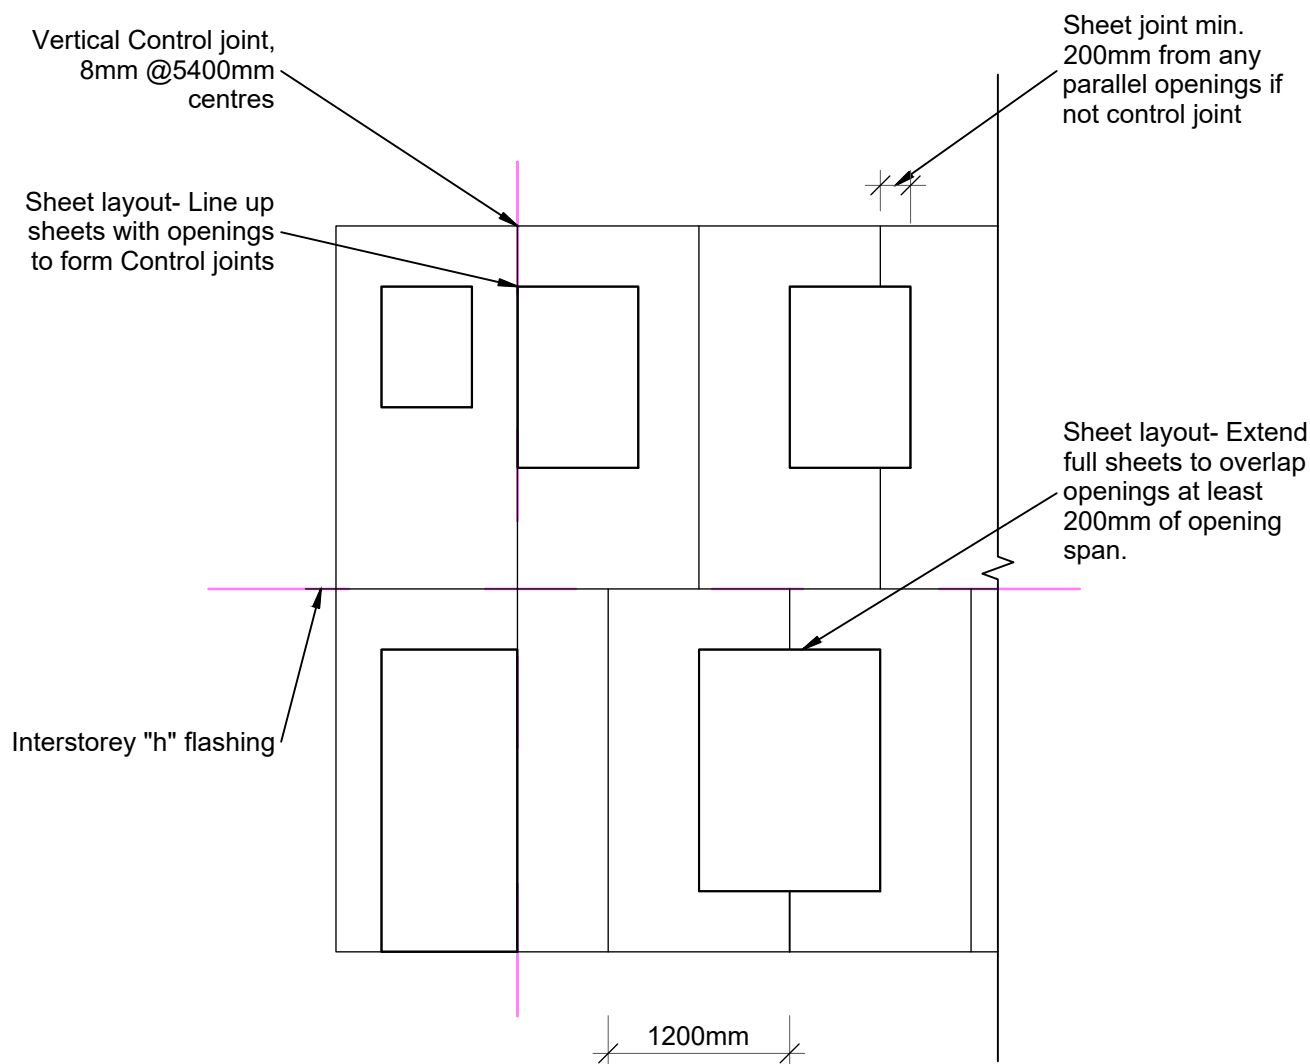
Reference: MPT_F082

Date: June 2019

Scale: 1 : 20 @ A4

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Notes:

1. All sheet edges shall line through and be supported by a framing member.
2. Sheet joints must NOT coincide with joinery unless a control joint is to be formed.
3. 2-3mm gap at joints between sheets.
4. Locate any interstorey joints as per board manufacturers specifications.
5. Stagger sheet joints to interstorey level.

Flashings:

- Horizontal "h", "Z" or uPVC flashing at inter-storey junctions.
- 8mm Vertical Control joints @5400mm centres max.
- 12mm Inter-storey expansion joints as required and in internal corners.

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MPT Fibreclad System

Wall - Sheet Layout

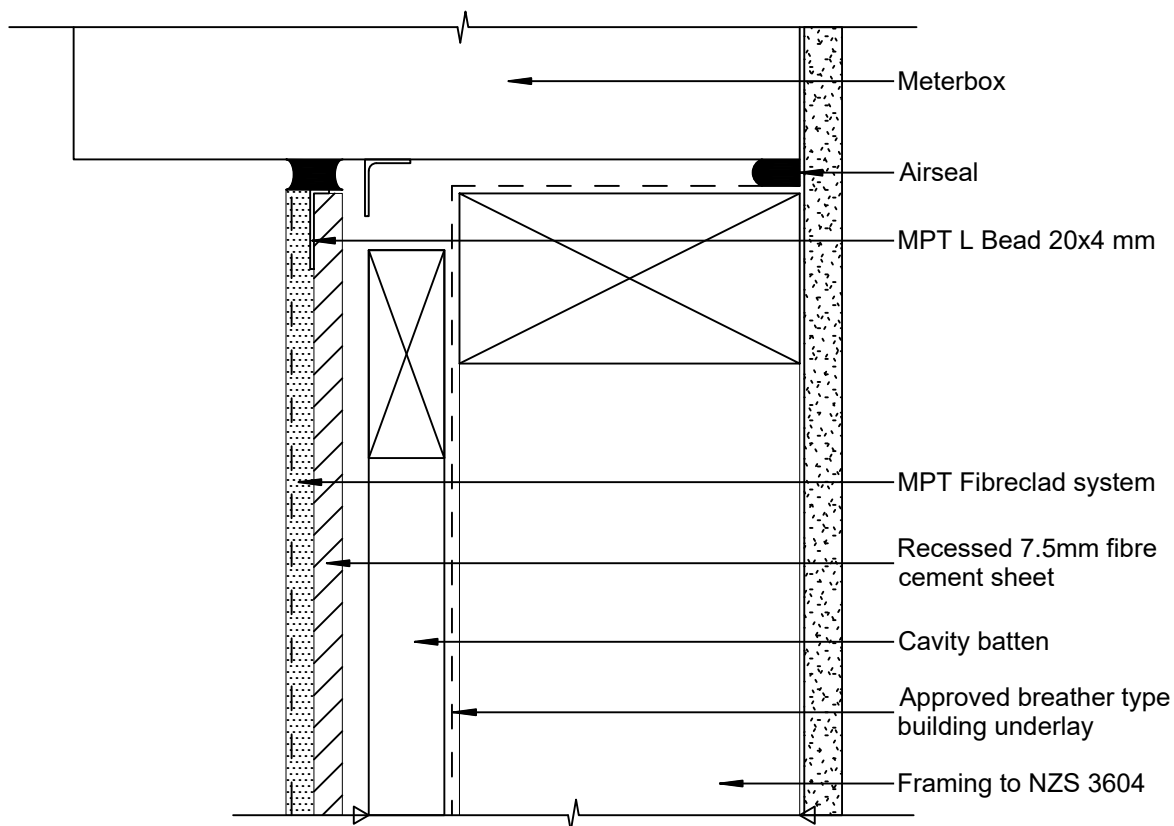
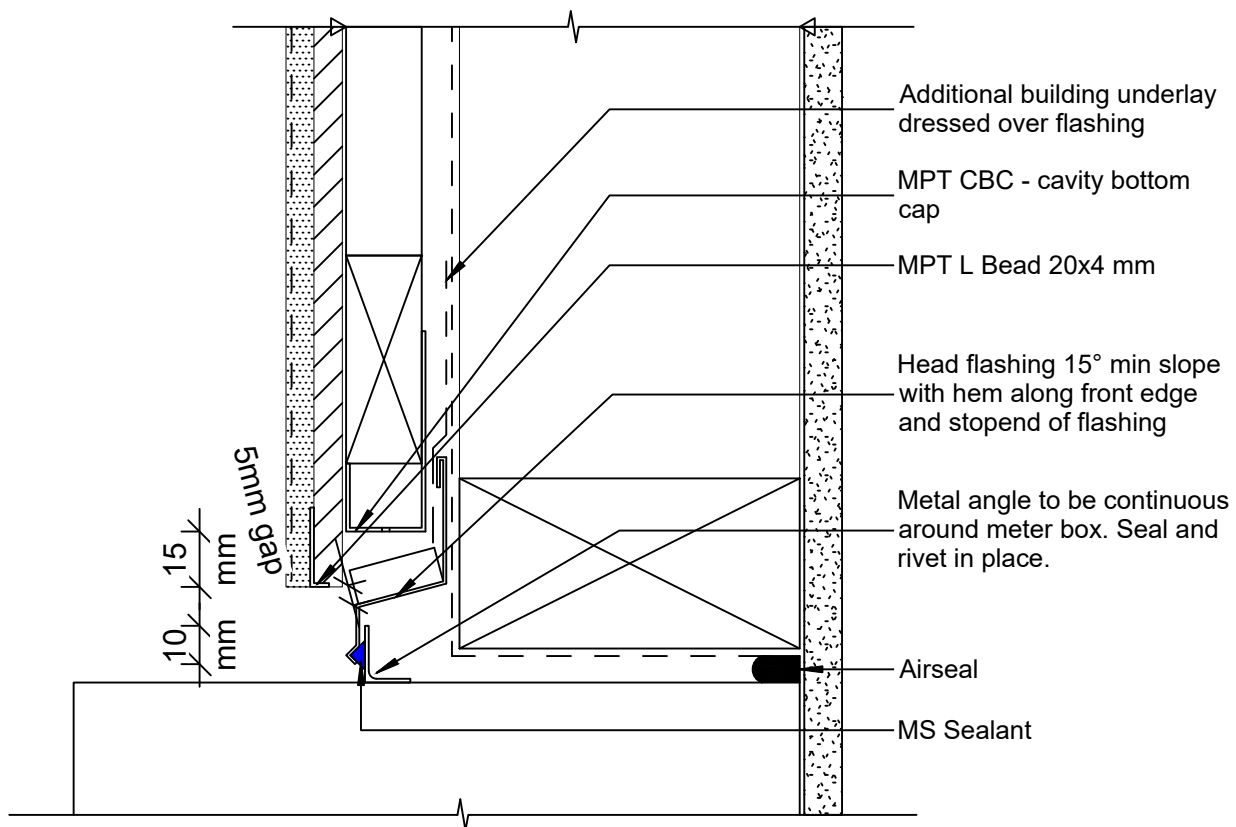
Reference: MPT_F084

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MPT Fibreclad System

Wall - Meterbox Wall Section

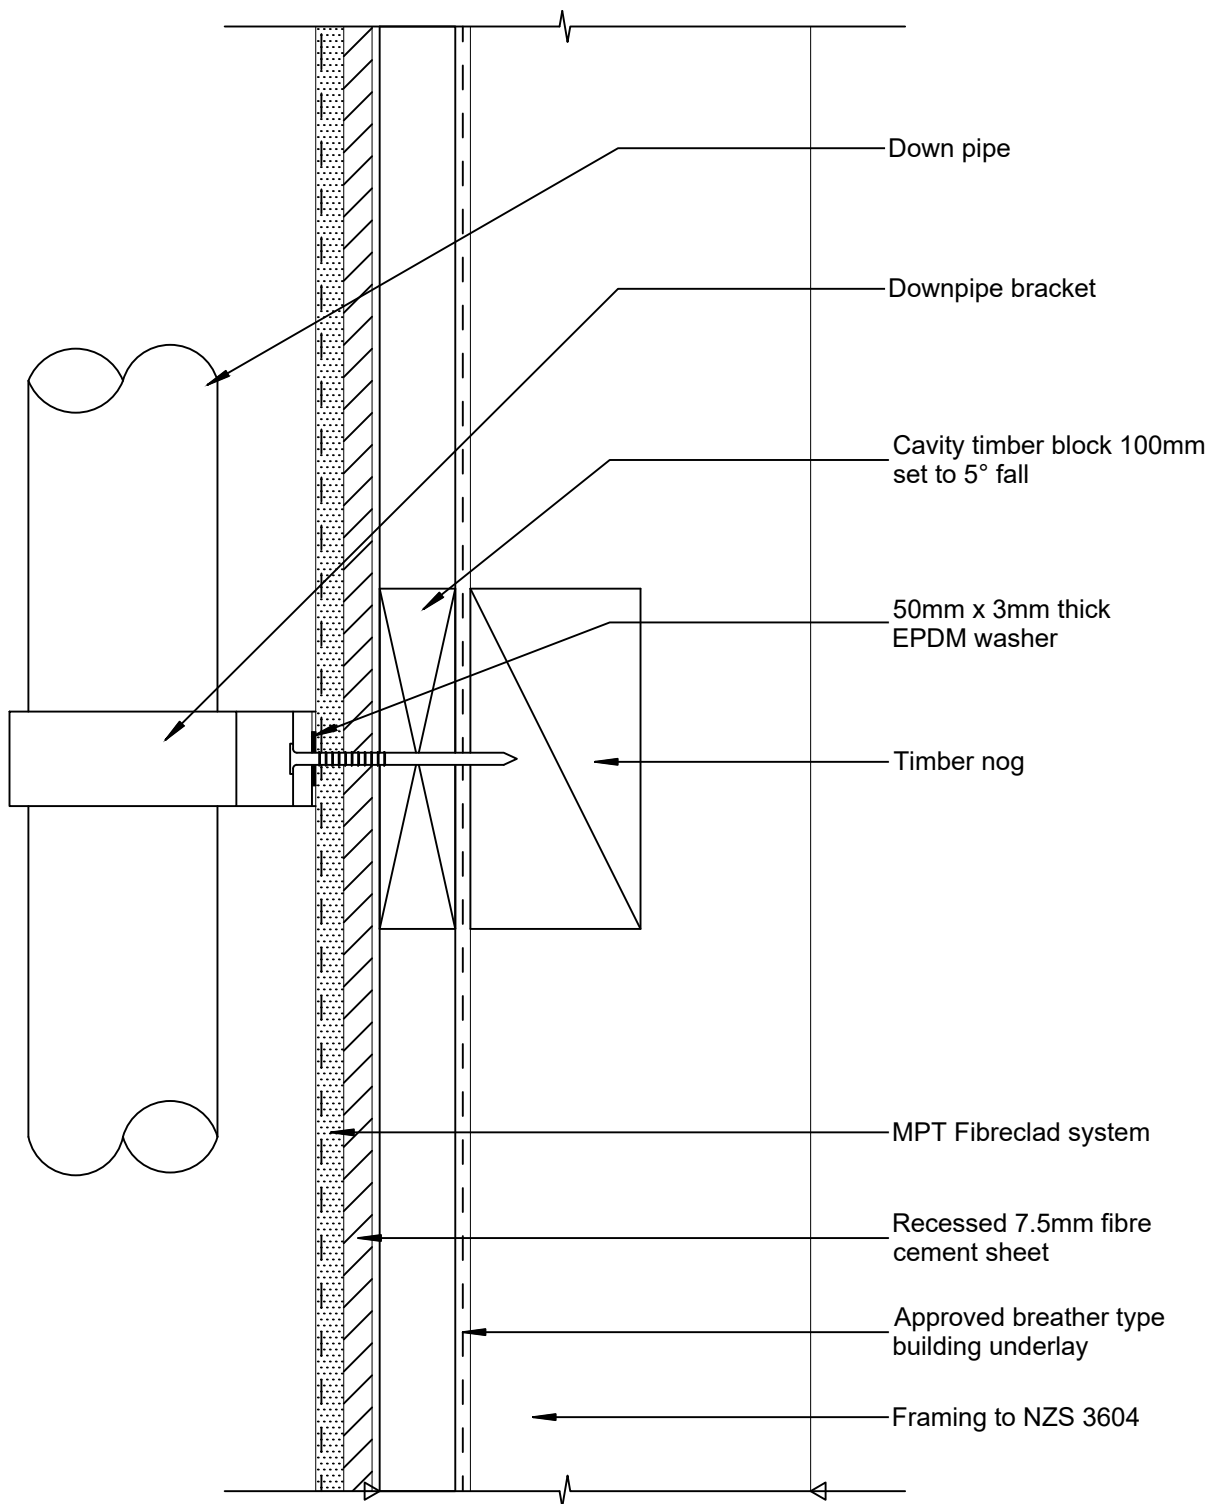
Reference: MPT_F085

Date: June 2019

Scale: 1 : 2 @ A4

Revision: 2

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MPT Fibreclad System Wall Downpipe

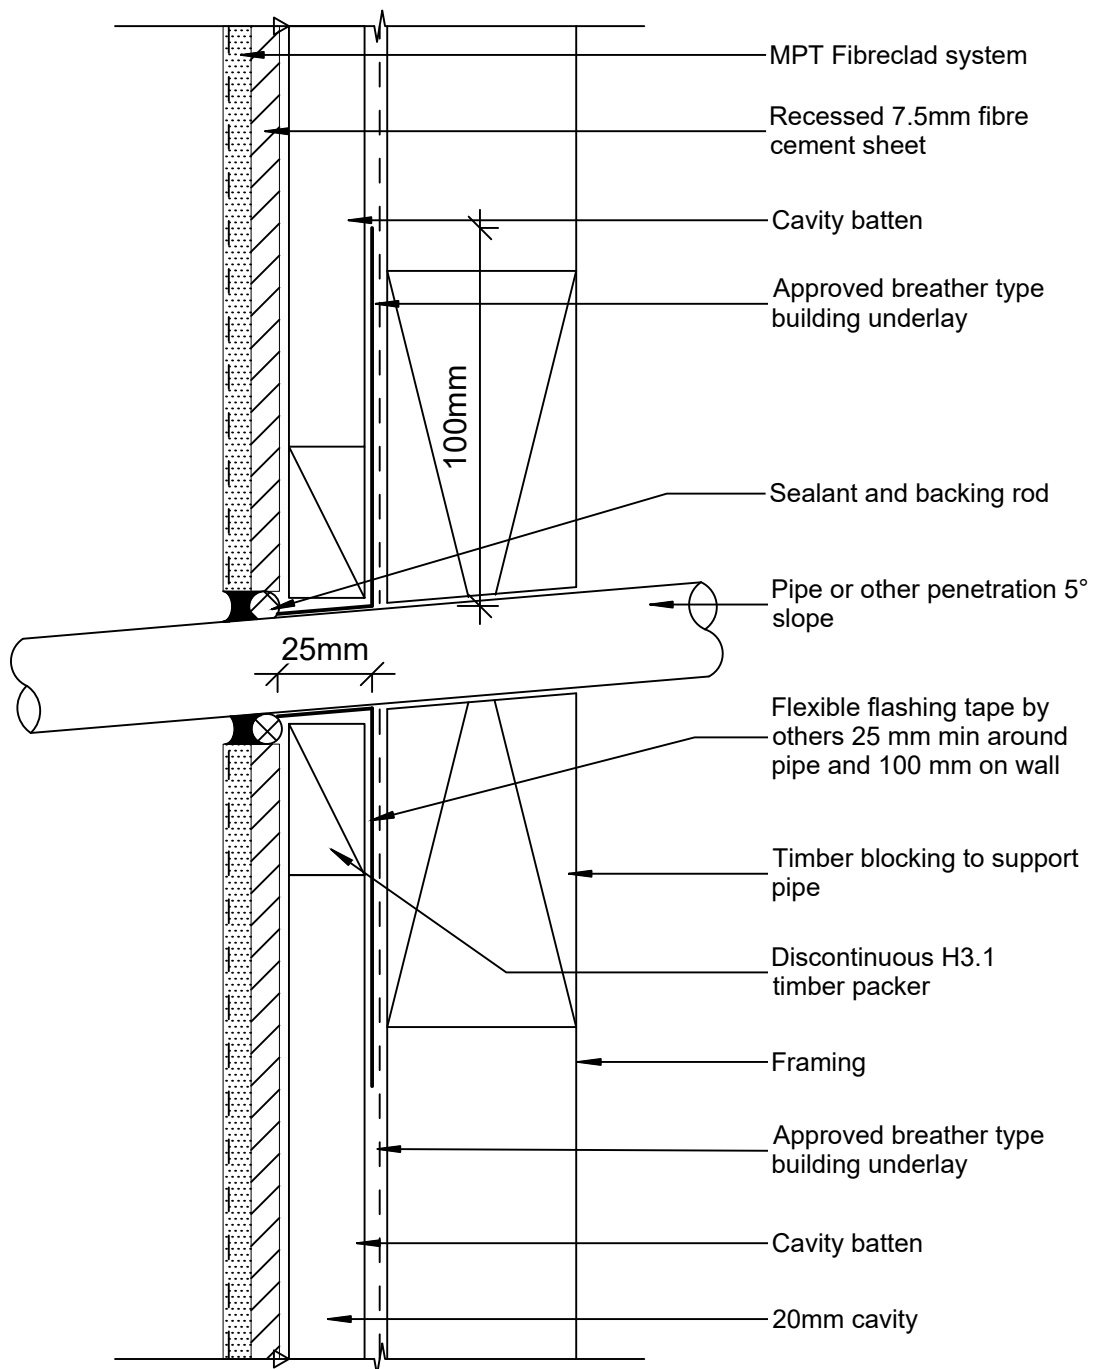
Reference: MPT_F086

Date: June 2019

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Revision: 2

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MPT Fibreclad System Wall - Pipe Penetration

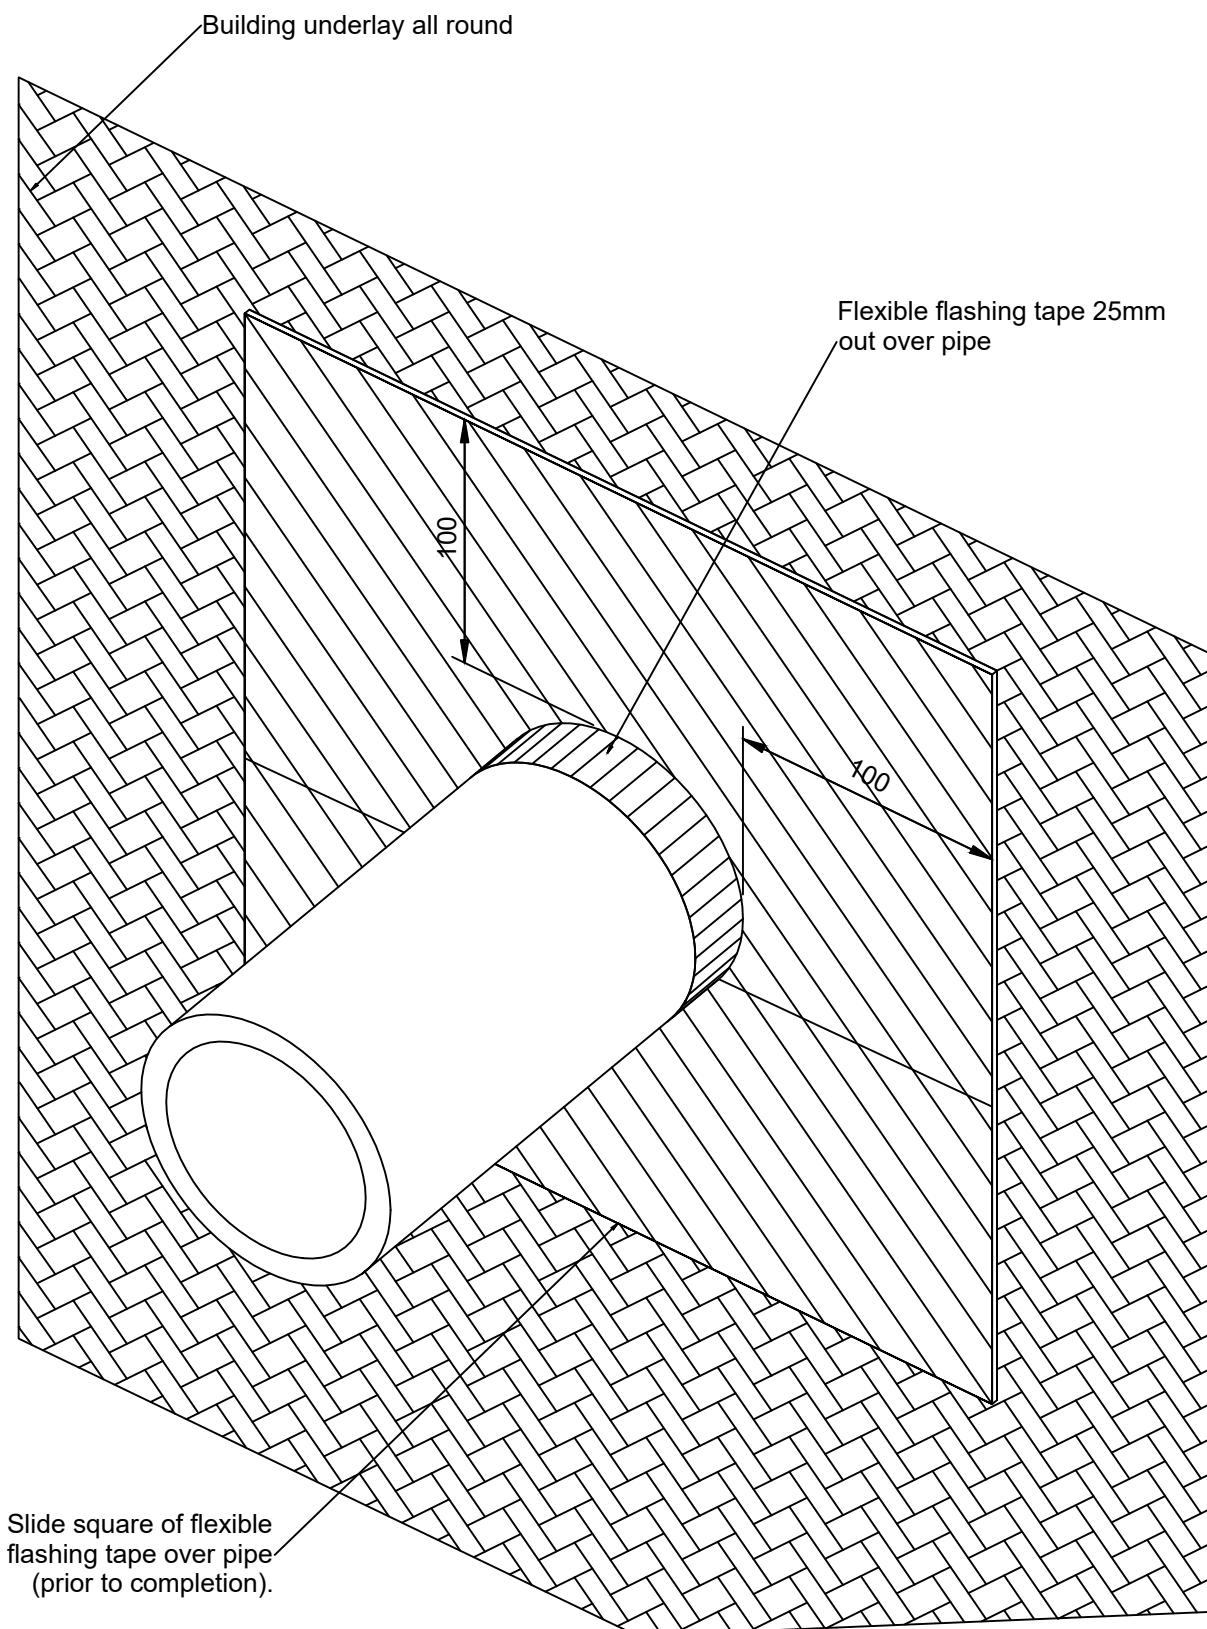
Reference: MPT_F087

Date: June 2019

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Revision: 2

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MPT Fibreclad System

Wall - Typical Pipe Penetration

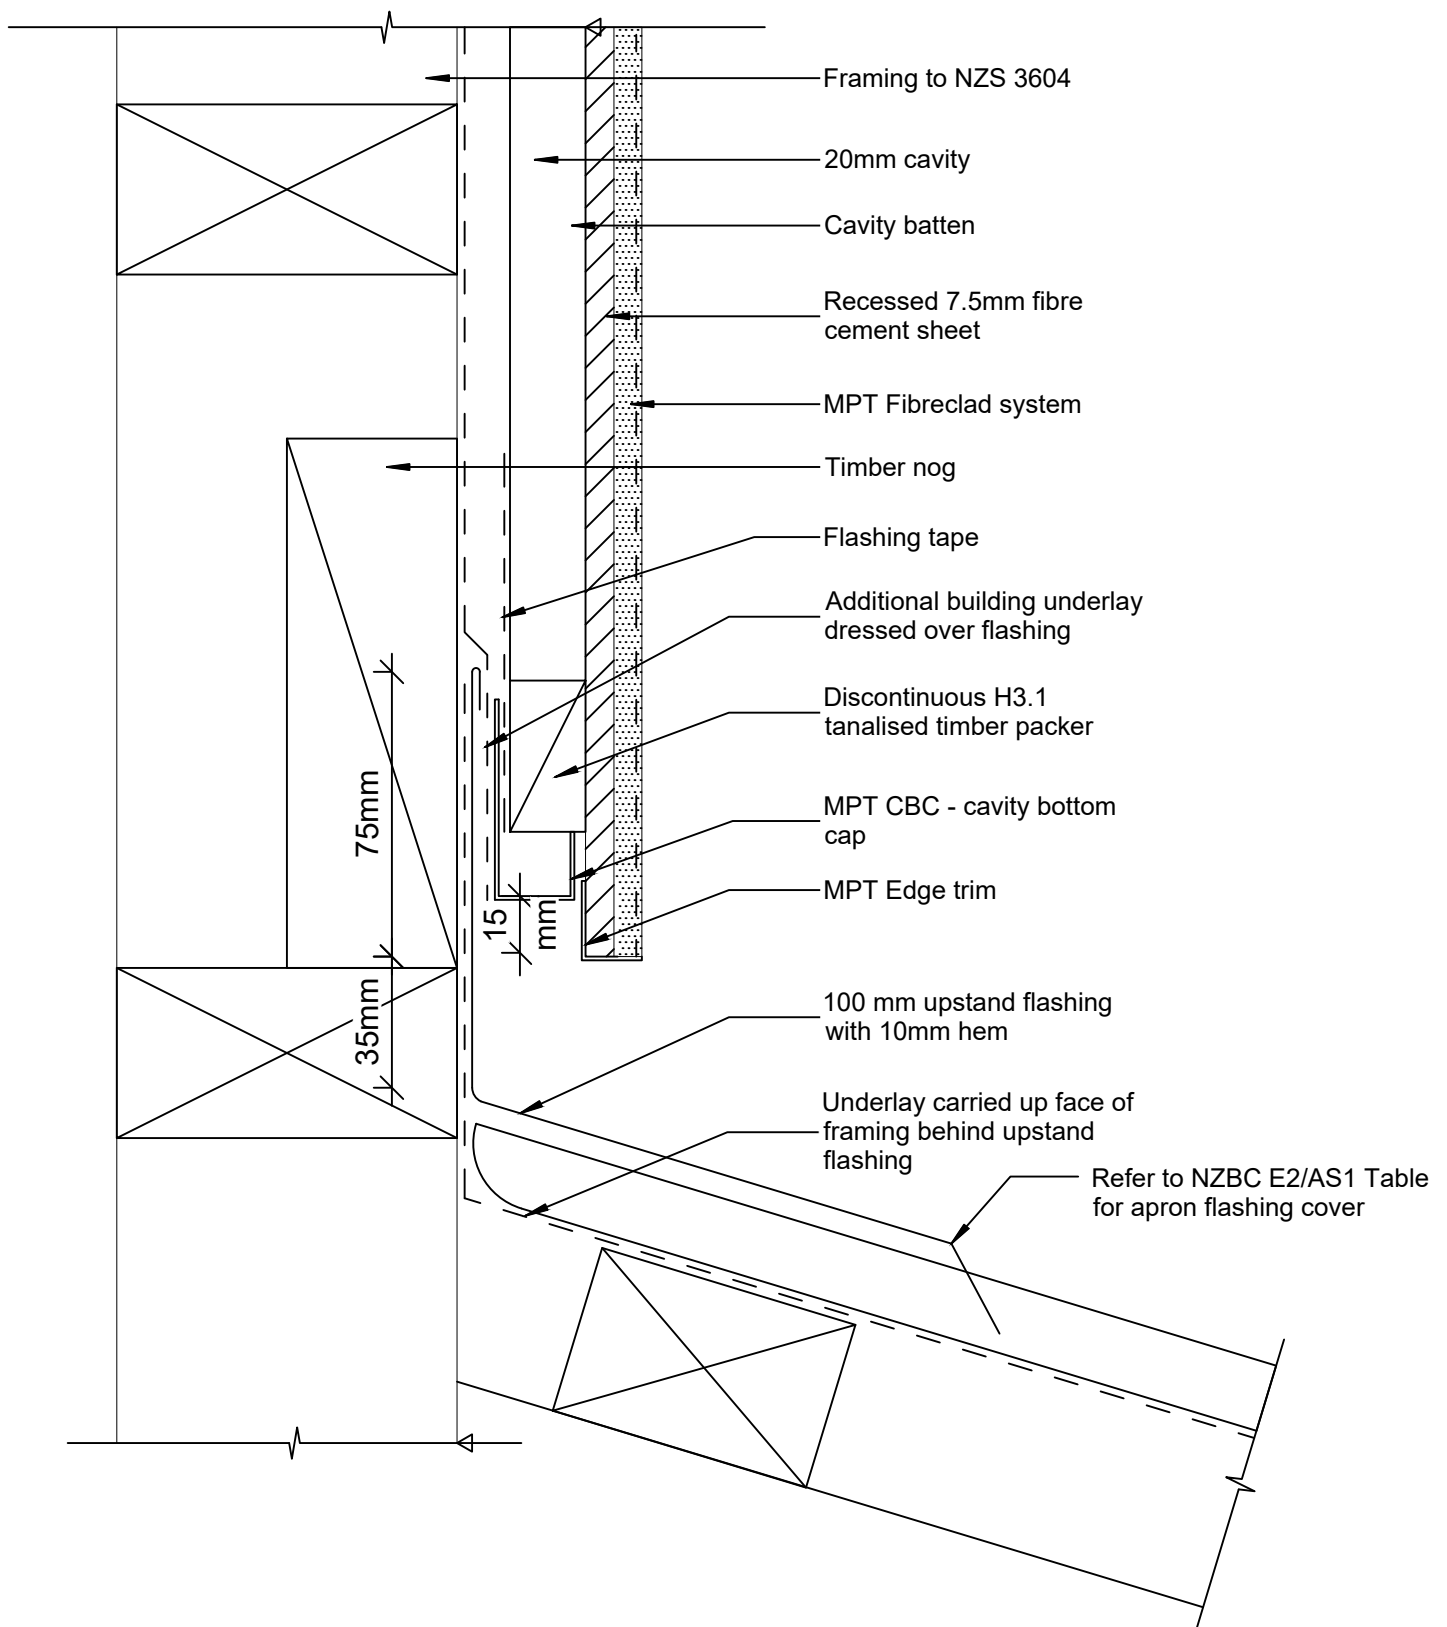
Reference: MPT_F088

Date: June 2019

Scale: 1 : 5 @ A4

Revision: 2

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MPT Fibreclad System

Roof - Wall Junction

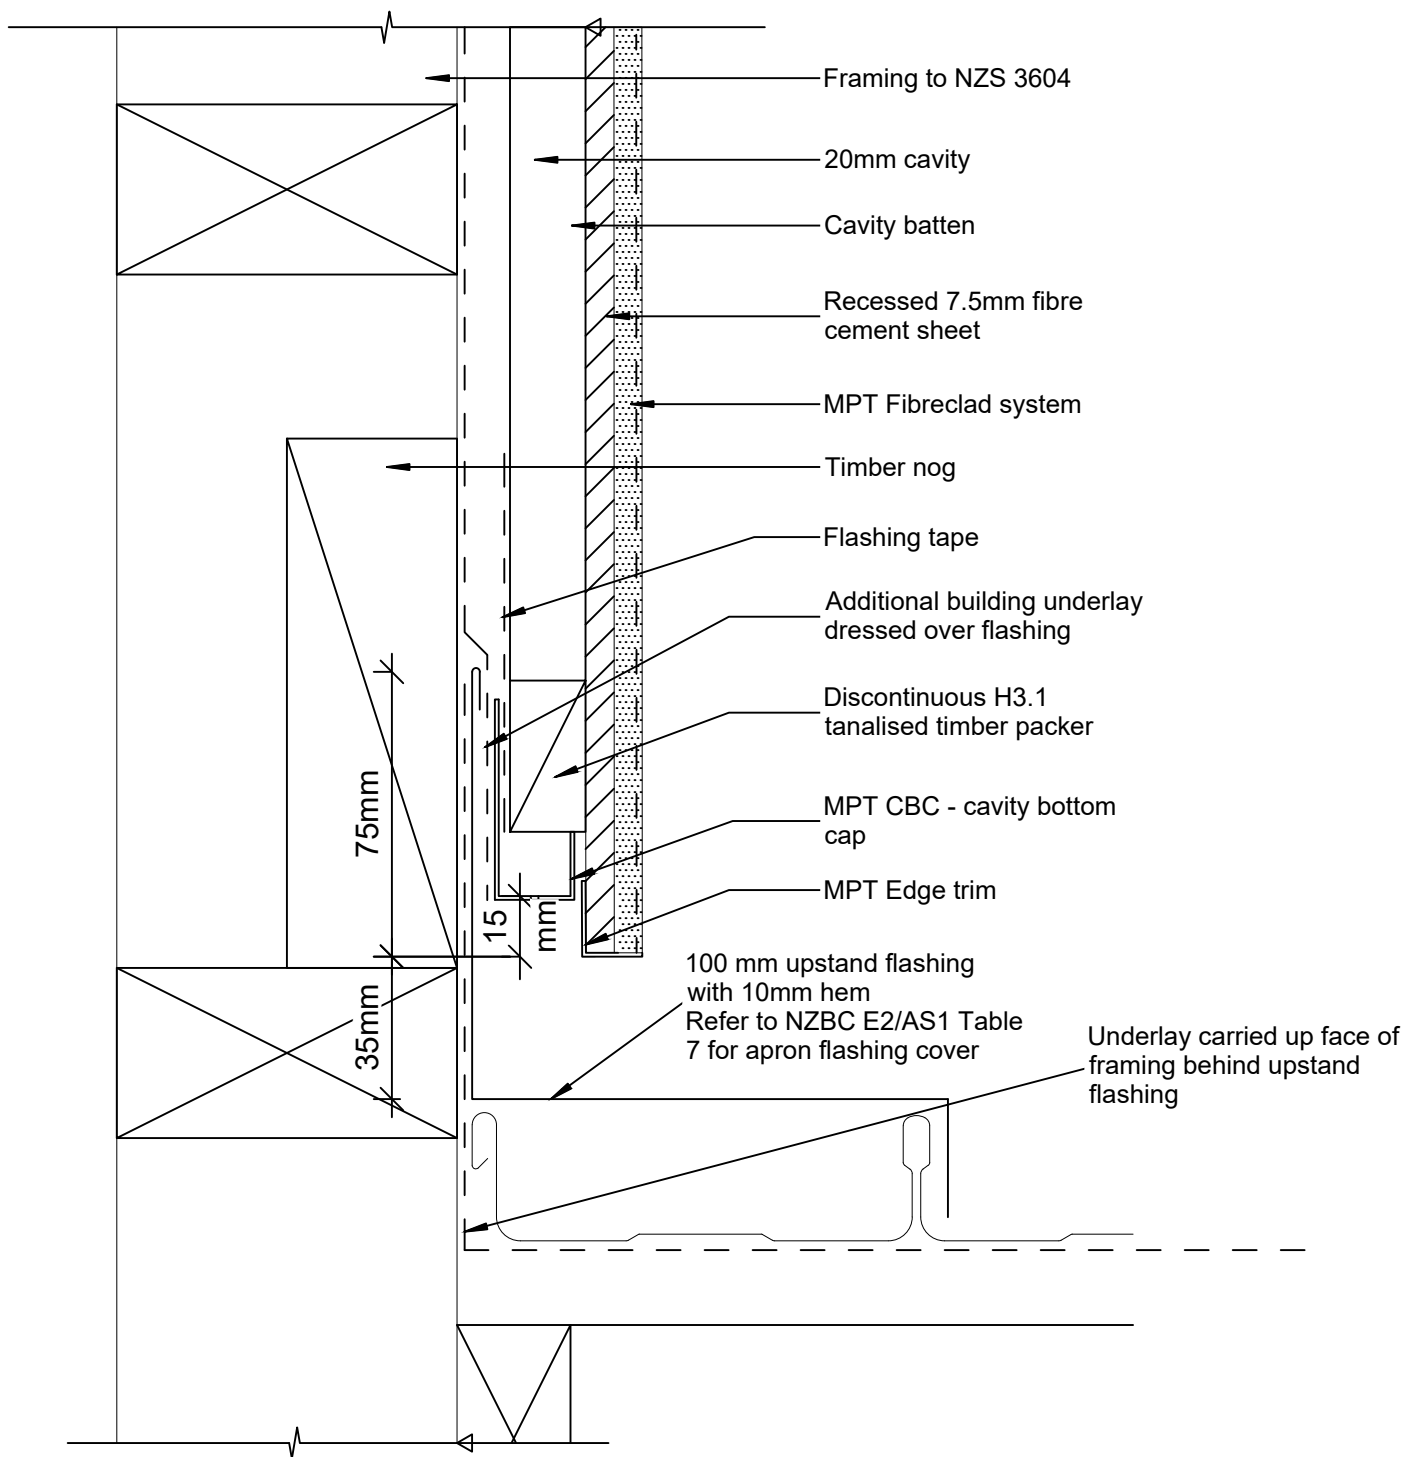
Reference: MPT_F090

Date: June 2019

Scale: 1 : 2 @ A4

Revision: 2

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MPT Fibreclad System

Roof - Wall Junction - Flat Roof

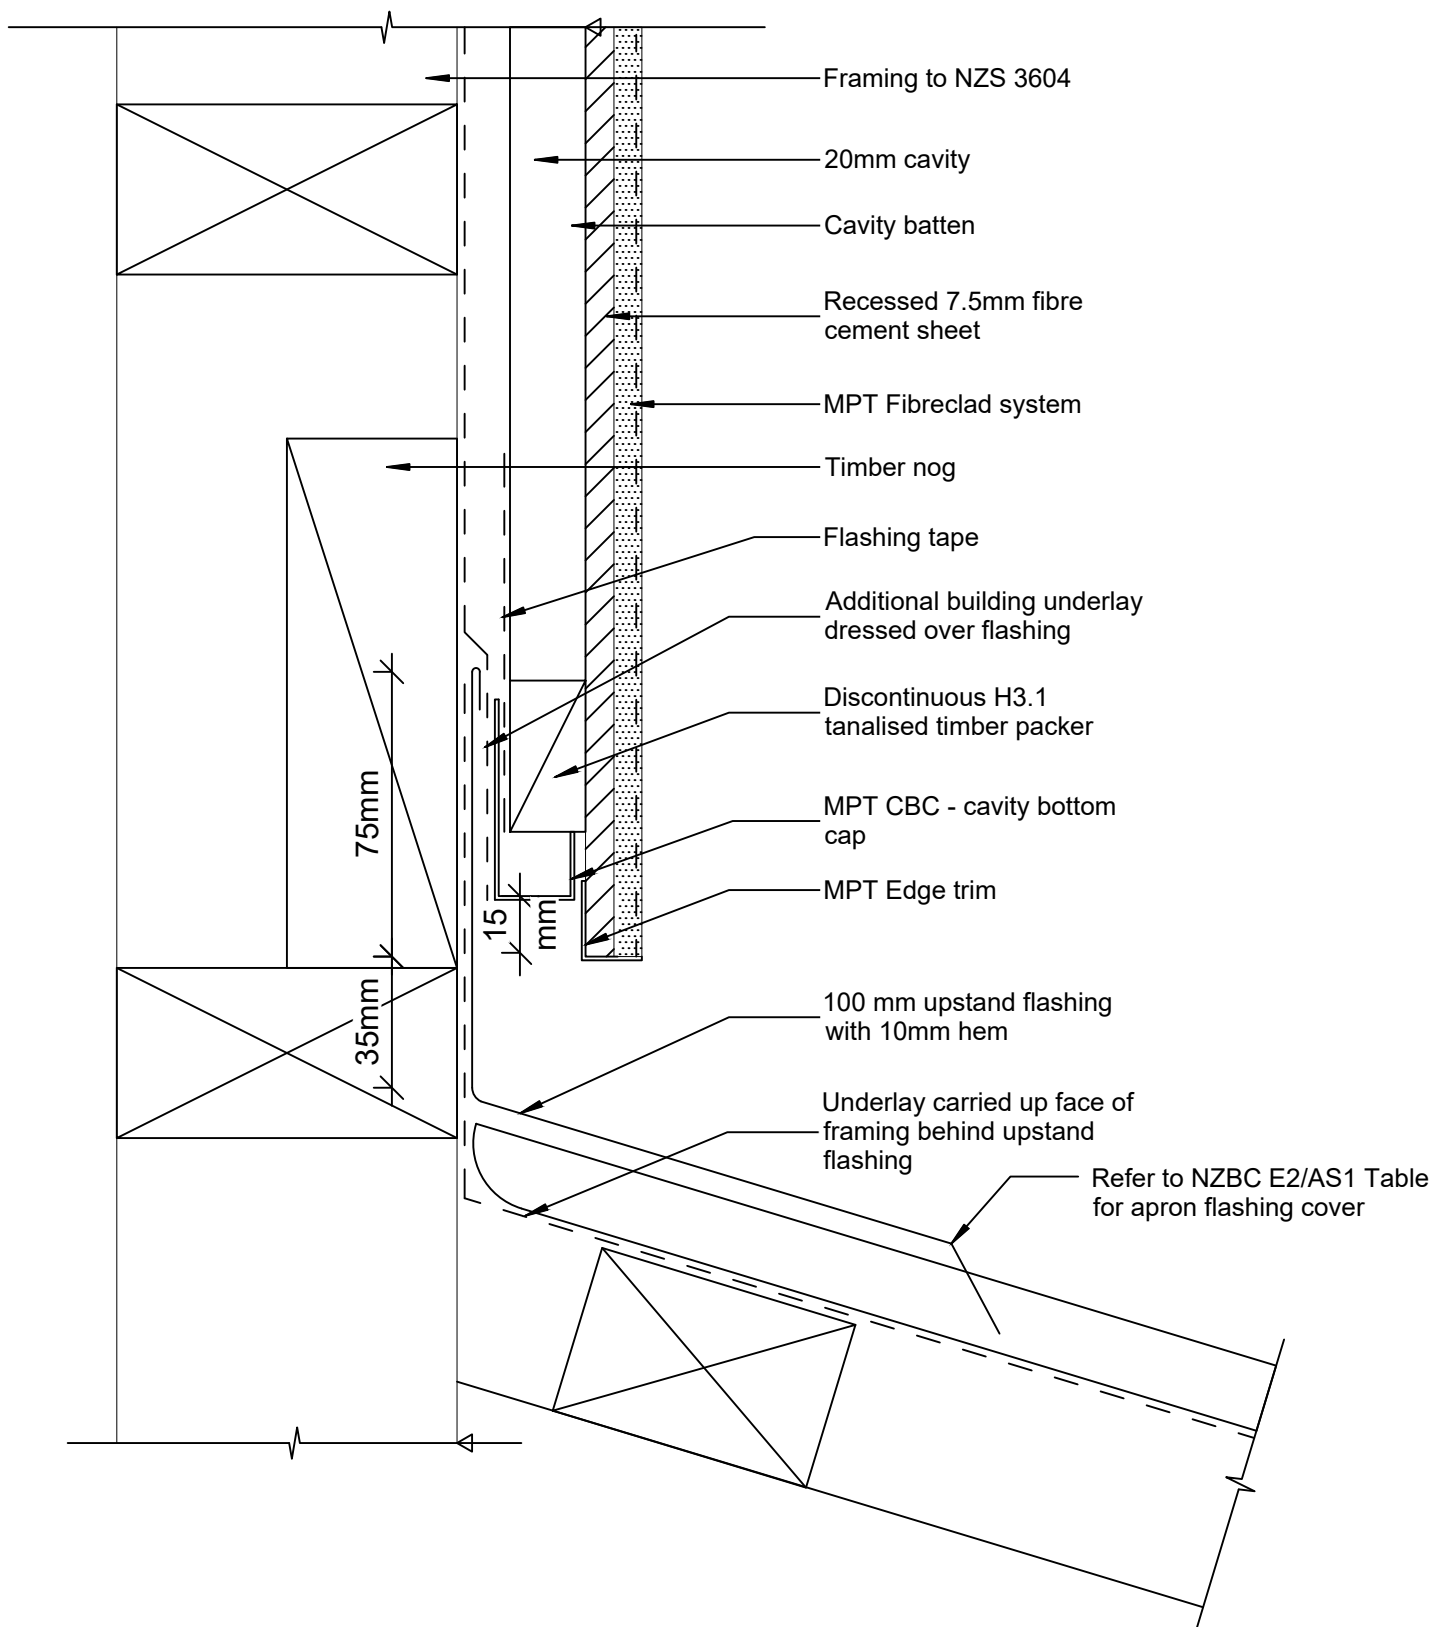
Reference: MPT_F090

Date: June 2019

Scale: 1 : 2 @ A4

Revision: 2

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MPT Fibreclad System

Roof - Wall Junction - Sloped Roof

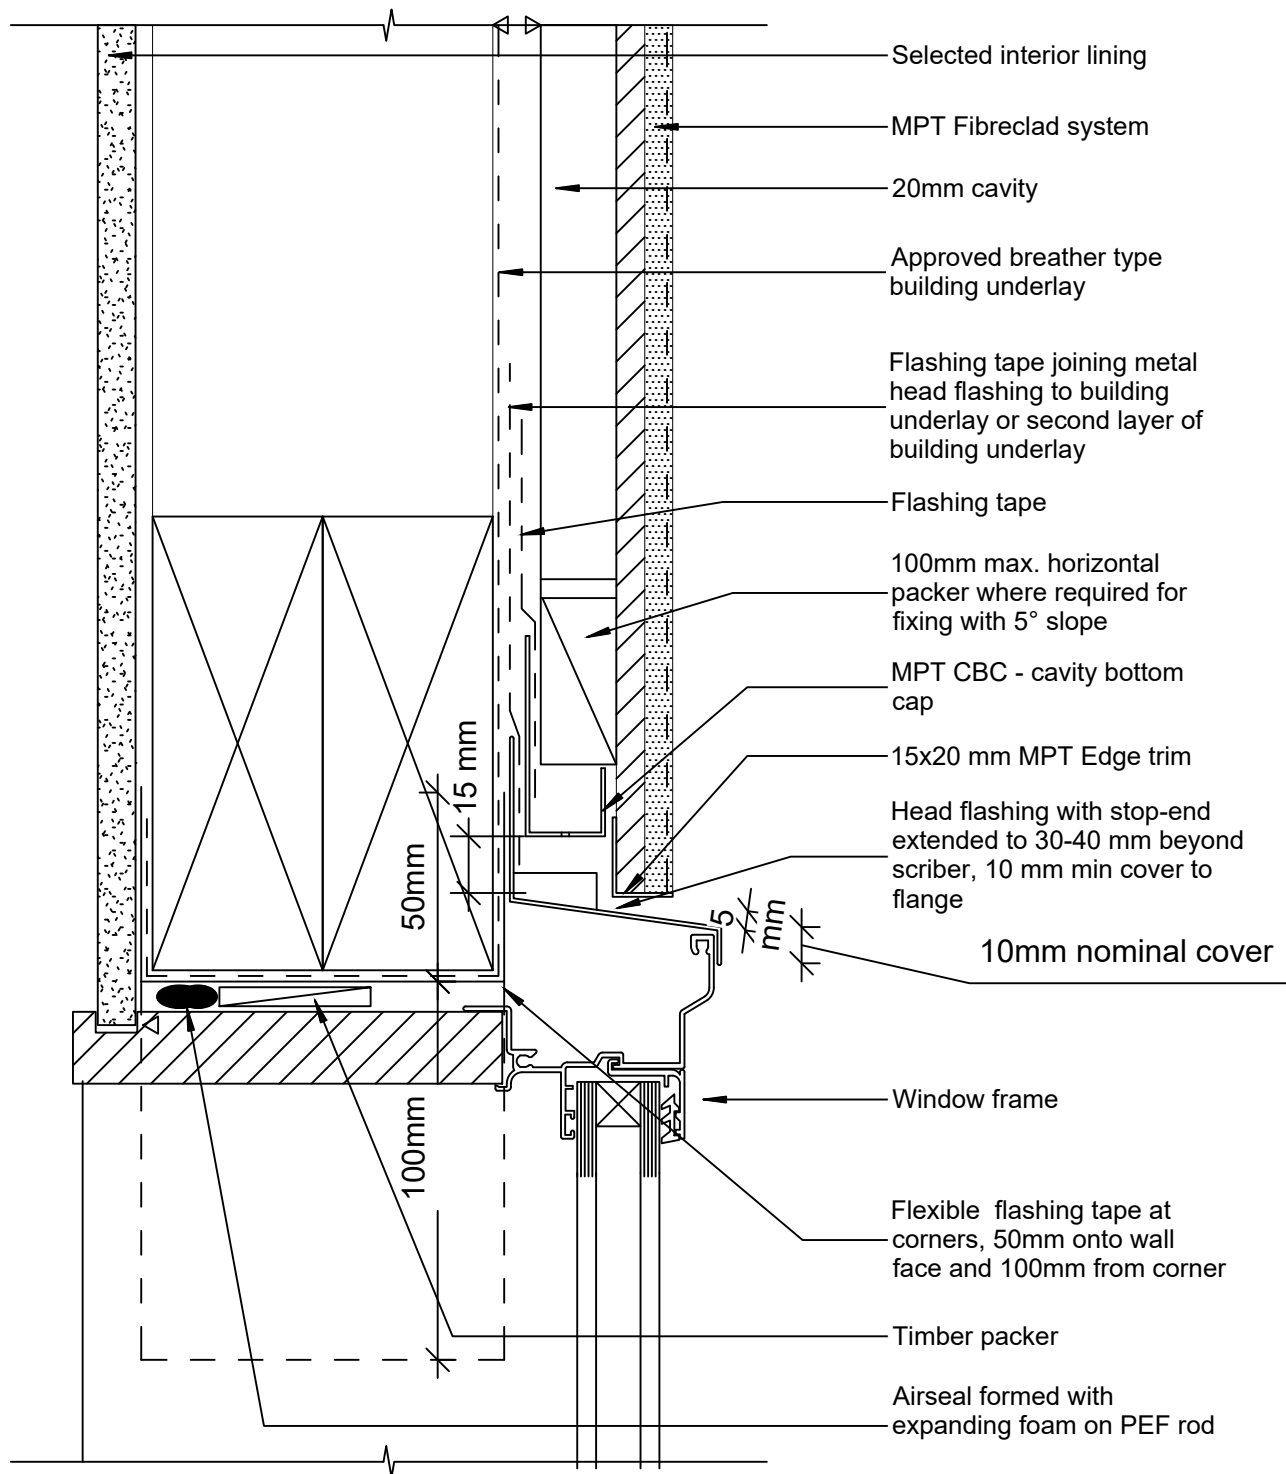
Reference: MPT_F091

Date: June 2019

Scale: 1 : 2 @ A4

Revision: 2

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MPT Fibreclad System Window - Aluminium Head Detail

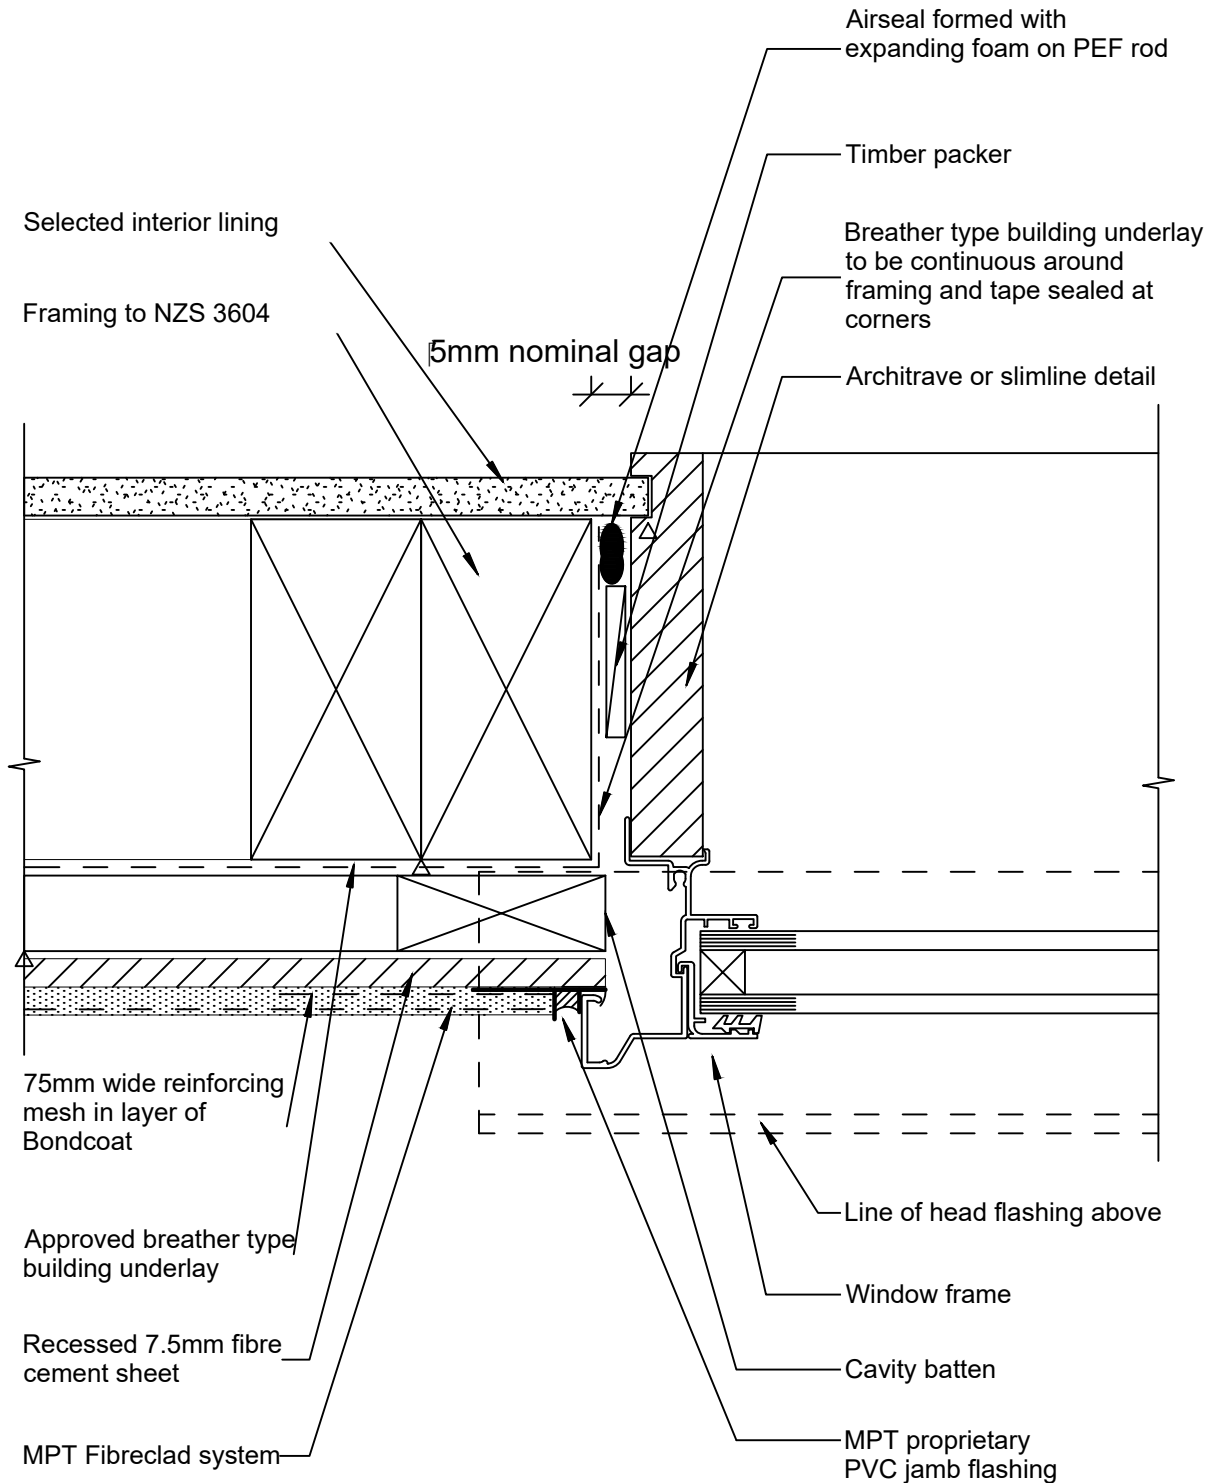
Reference: MPT_F101

Date: June 2019

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MPT Fibreclad System

Window - Aluminium Jamb Detail

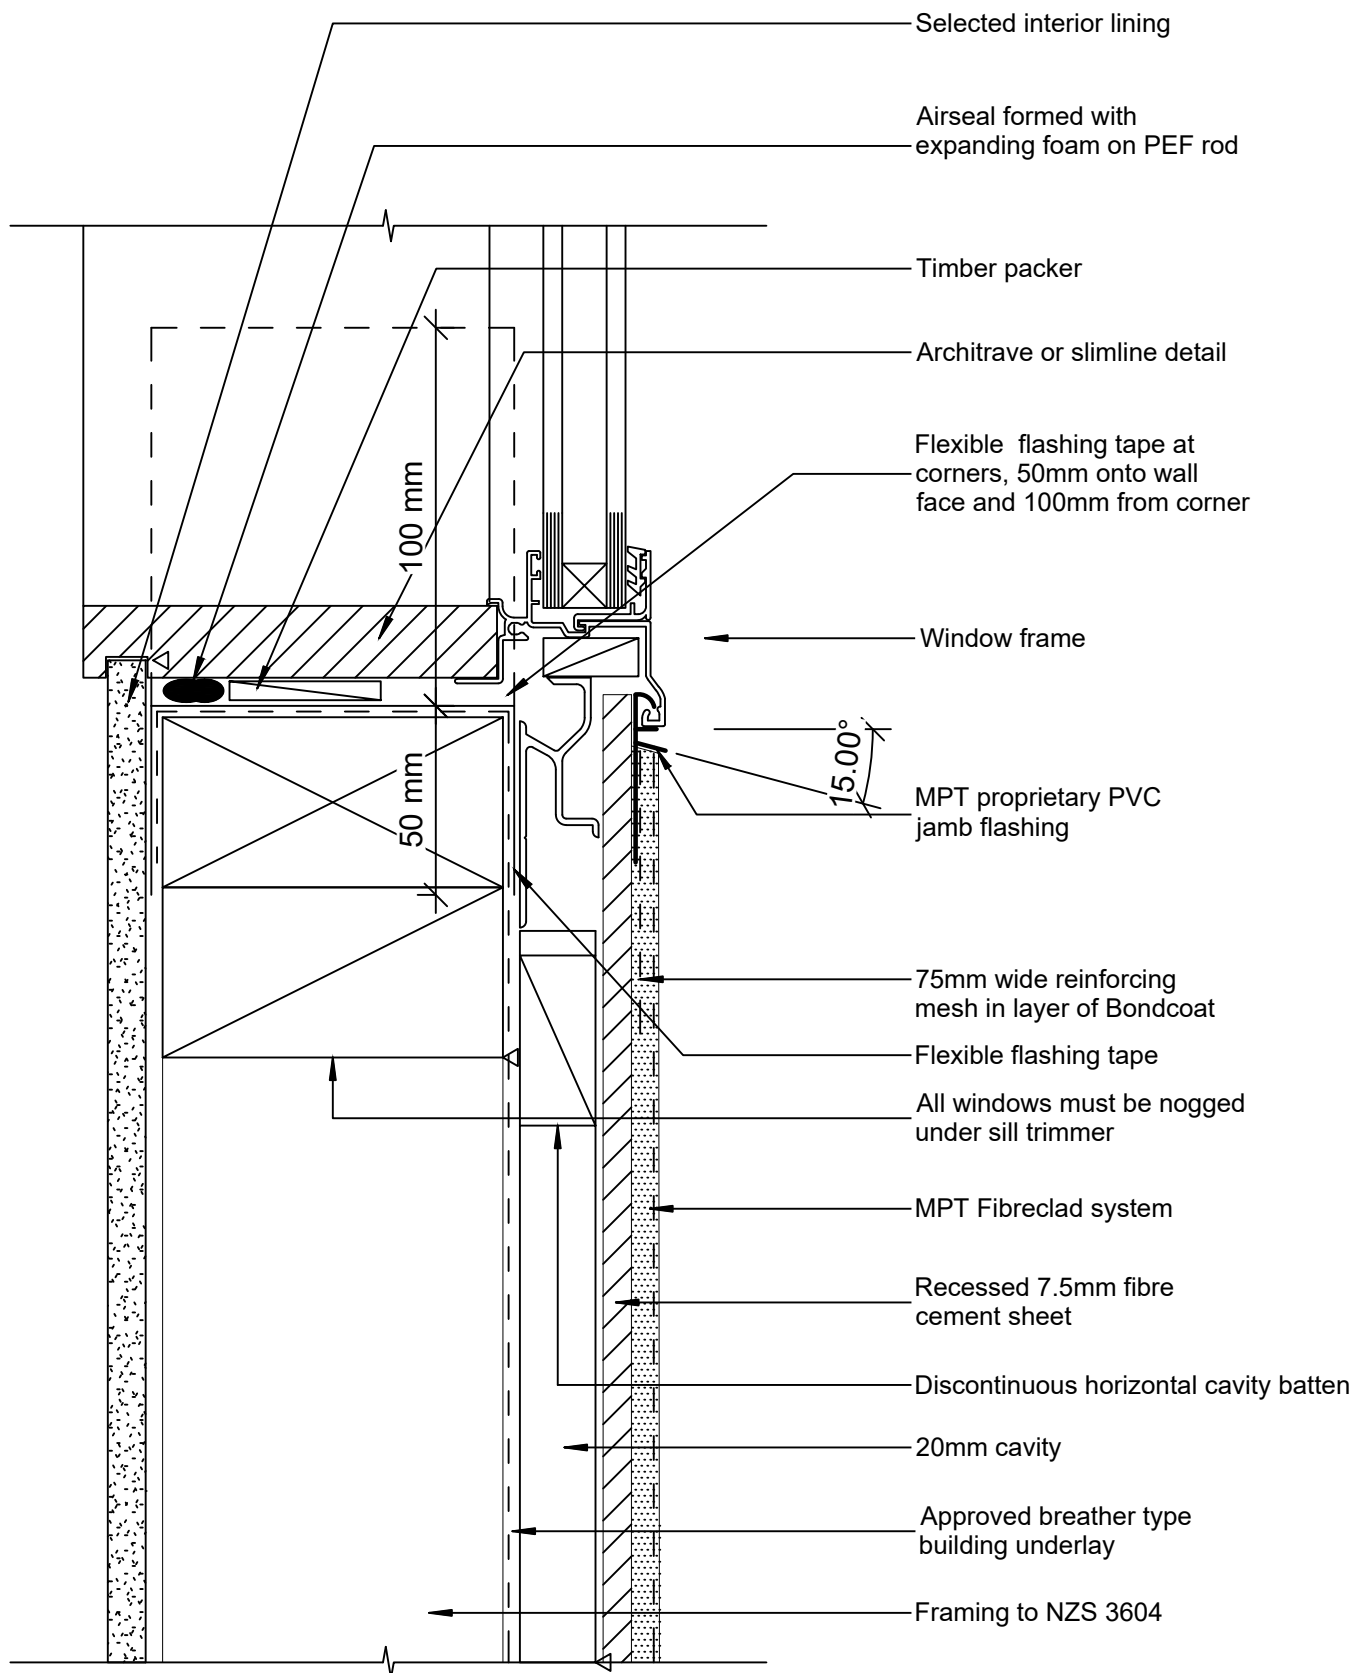
Reference: MPT_F102

Date: June 2019

Scale: 1 : 2 @ A4

Revision: 2

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MPT Fibreclad System

Window - Aluminium Sill Detail

Reference: MPT_F103

Date: June 2019

Scale: 1 : 2 @ A4

Revision: 2

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